LEGEND & ABBREVIATIONS DESCRIPTION **RETAINING WALL** STORM DRAIN LINE SANITARY SEWER LINE SET BACK LINE SWALE FLOW DIRECTION CATCH BASIN JUNCTION BOX AREA DRAIN SANITARY SEWER CLEANOUT CURB INLET SANITARY SEWER MANHOLE SPOT ELEVATION FLOW DIRECTION **BENCHMARK** TREE TO BE REMOVED

EC END OF CURVE FG FINISH GRADE FL FLOW LINE GAR SL GARAGE SLAB INV. INVERT GRADE LNDG LANDING PRC POINT OF REVERSE CURVATURE PCC POINT OF COMPOUND CURVATURE RIM RIM INLET GRADE SSCO SANITARY SEWER CLEAN OUT TC TOP OF CURB TW TOP OF WALL (EARTH RETAINED)

TRACT IMPROVEMENTS & STANDARDS

1. ALL IMPROVEMENTS WITHIN/OR ADJACENT TO PROPOSED PRIVATE DRIVE (P.S.E., E.V.A.E.) TO BE PER COUNTY OF ALAMEDA PUBLIC WORKS STANDARDS. REFER TO IMPROVEMENT PLANS BY MARK THOMAS & CO., INC. FOR PREVIOUSLY APPROVED TRACT DEVELOPMENT.

(E) STORM DRAIN LINES

BACK OF CURVE

CLEAN OUT

(E) SANITARY SEWER LINES

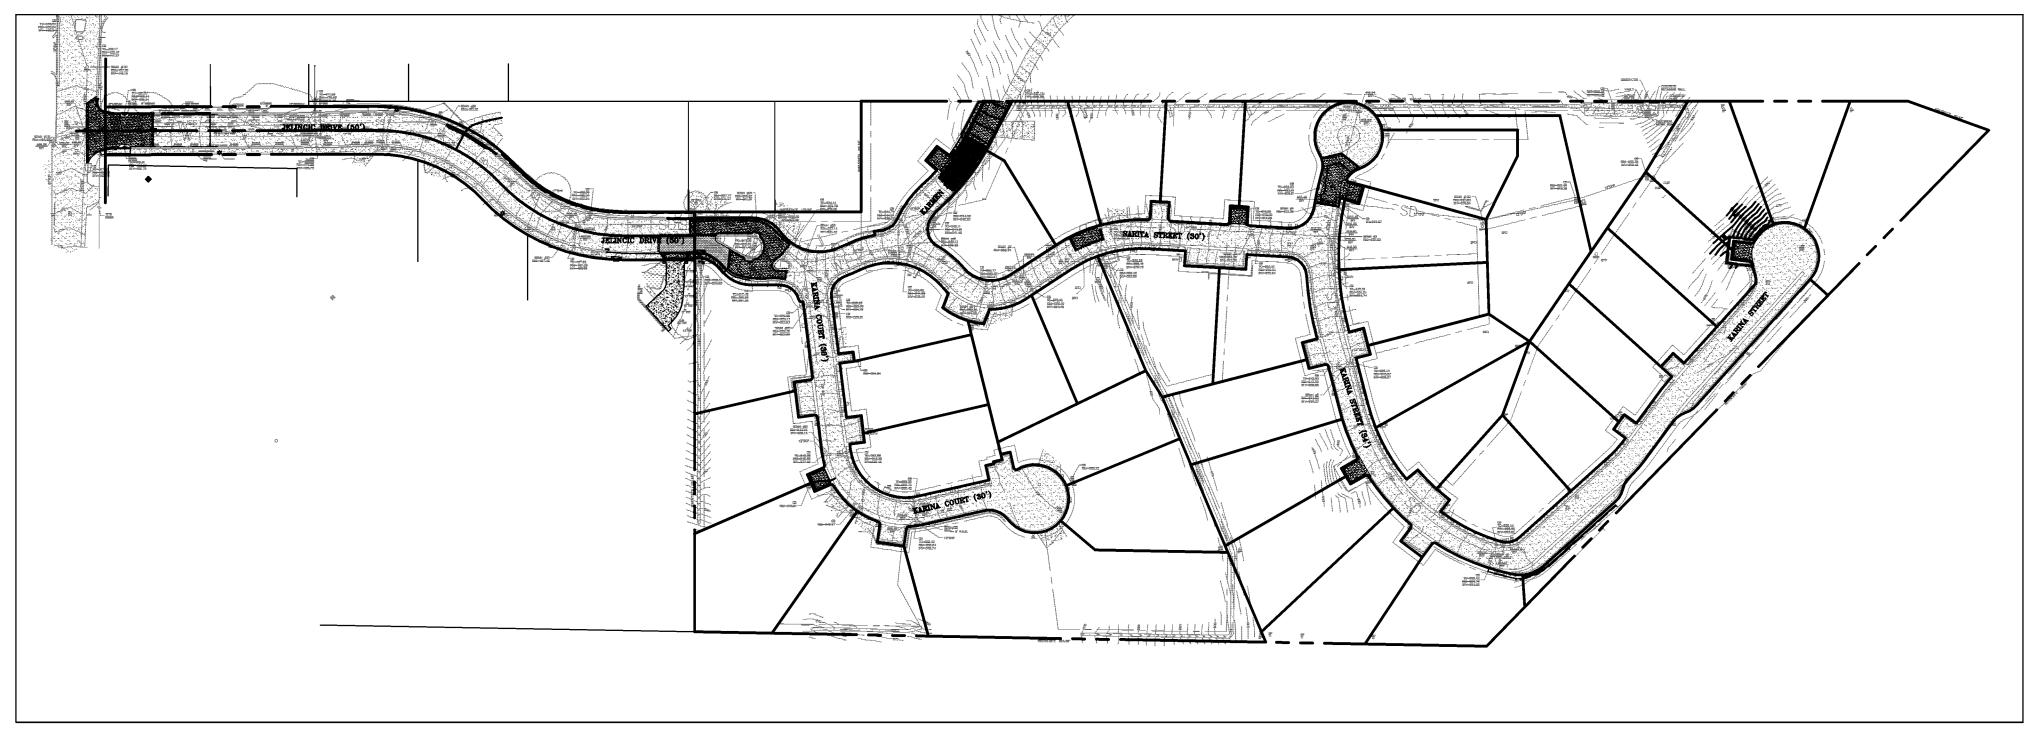
BOTTOM OF WALL (EARTH RETAINED)

- 2. UNLESS OTHERWISE STATED, ALL NECESSARY EASEMENTS AND STREET RIGHT-OF-WAY SHALL BE DEDICATED AND ALL IMPROVEMENTS SHALL BE DESIGNED AND INSTALLED AT NO COST TO THE COUNTY OF ALAMEDA.
- 3. ALL IMPROVEMENTS SHALL BE DESIGNED AND CONSTRUCTED IN ACCORDANCE WITH THE ALAMEDA COUNTY FLOOD CONTROL STANDARD SPECIFICATION AND DETAILS, UNLESS OTHERWISE INDICATED.
- 4. ALL DESIGN WORK SHALL BE PERFORMED BY THE SUBDIVIDER'S ENGINEER, UNLESS OTHERWISE INDICATED.
- 5. ALL STORM DRAIN INLETS SHALL HAVE A SIGN STENCILED/INSTALL "NO DUMPING-DRAINS TO BAY".
- 6. ALL IMPROVEMENTS SHALL BE DESIGNED AND CONSTRUCTED IN ACCORDANCE WITH ORO LOMA SANITARY DISTRICT STANDARD SPECIFICATIONS AND DETAILS, UNLESS OTHERWISE INDICATED.

IMPROVEMENT PLANS for

TRACT 6102

HAYWARD (UNINCORPORATED) COUNTY OF ALAMEDA, CALIFORNIA



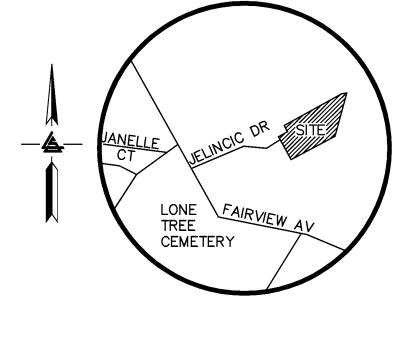
 $\frac{KEY MAP}{SCALE 1" = 100'}$

RETAINING WALL NOTES

- 1. TW/FG REPRESENTS FINISHED EARTHEN GRADE OR PAVEMENT ELEVATION AT TOP OF WALL, NOT ACTUAL TOP OF WALL MATERIAL. BW/FG REPRESENTS FINISH EARTHEN GRADE OR PAVEMENT ELEVATION AT BOTTOM OF WALL NOT INCLUDING FILL FOUNDATION. GRADES INDICATED ON THESE PLANS REFER TO THE FINISHED GRADES ADJACENT TO THE RETAINING WALL, NOT INCLUDING FOOTING, FREEBOARD, ETC.
- 2. DIMENSIONS SHOWN IN BRACKETS SHOWN AS [X.X'] DENOTE THE EFFECTIVE WALL HEIGHT ONLY. THE ACTUAL WALL HEIGHT AND DEPTH MAY DIFFER DUE TO CONSTRUCTION REQUIREMENTS.
- 3. REFER TO SPECIFIC WALL CONSTRUCTION DETAIL FOR STRUCTURAL ELEMENTS, FREEBOARD, AND EMBEDMENT.
- 4. REFER TO ARCHITECTURAL, LANDSCAPE ARCHITECTURE, AND/OR STRUCTURAL PLANS FOR DETAILS, WALL ELEVATIONS, SUBDRAINAGE, WATERPROOFING, FINISHES, COLORS, STEEL REINFORCING, MATERIALS, ETC. PROVIDE CLIPS OR OTHER MEANS OF SECURING FINISH MATERIALS AS NECESSARY (WET SET INTO THE WALL).
- 5. ALL RETAINING WALLS SHOULD HAVE A BACK-OF-WALL SUB-SURFACE DRAINAGE SYSTEM INCLUDING WEEPHOLES TO PREVENT HYDROSTATIC PRESSURE.
- 6. SEE DETAIL SHEET FOR SPECIFIC INFORMATION.
- 7. PROVIDE GUARDRAIL (WHERE APPLICABLE AND DESIGNED BY OTHERS) AS REQUIRED FOR GRADE SEPARATION OF 30 INCHES OR MORE MEASURED 5' HORIZONTALLY FROM FACE OF WALL, PER CBC.

GEOTECHNICAL ENGINEERING NOTE:

IT IS THE RESPONSIBILITY OF THE CONTRACTOR TO RETAIN A LICENSED GEOTECHNICAL ENGINEER FOR RECOMMENDATIONS AND OBSERVATIONS OF WORK PROPOSED BY THIS PLAN. THE GEOTECHNICAL ENGINEER OF RECORD MAY MAKE RECOMMENDATIONS THAT WILL SUPERCEDE THESE PLANS. SHOULD DISCREPANCIES ARISE, CONTACT LEA & BRAZE ENGINEERING, INC. AT 510—887—4086.



VICINITY MAP
NO SCALE

<u>REFERENCES</u>

THIS IMPROVEMENT PLAN IS SUPPLEMENTAL TO:

1) UPDATED TOPOGRAPHIC SURVEY BY LEA AND SUNG ENGINEERING, INC., ENTITLED:

"TRACT 6102"

JELINCIC DRIVE

HAYWARD, CALIFORNIA

JOB NO.: 2050355

DATED: 5-05-05

2) IMPROVEMENT PLANS BY MARK THOMAS & CO INC., ENTITLED:

"TRACT 6102 GRADING PLAN"

HAYWARD, CALIFORNIA

"TRACT 6102 GRADING PLAN"
HAYWARD, CALIFORNIA
JOB NO.: 23-98012
DATED: MAY 1999

THE CONTRACTOR SHALL REFER TO THE ABOVE NOTED SURVEY AND PLAN, AND SHALL VERIFY BOTH EXISTING AND PROPOSED ITEMS ACCORDING TO THEM.

THE CONTRACTOR SHALL REFER TO THE LANDSCAPE ARCHITECT'S PLAN FOR FINE GRADING WITHIN MINOR LOCALIZED DRAINAGE IN PLANTING AND HARDSCAPE AREAS. TIE MINOR DRAIN LINES TO THE LARGER STORM DRAIN (SD) SYSTEM.

APPROVALS:

ALAMEDA COUNTY PUBLIC WORKS AGENCY:

IMPROVEMENT PLANS REVIEWED BY:

DATE:

DANIEL WOLDESENBET, Ph. D., P.E., COUNTY ENGINEER
R.E.C. 60306, REG. EXPIRES 6/30/12

BENCHMARK:

ALAMEDA COUNTY BENCHMARK ALAMEDA COUNTY STREET MONUMENT ON FAIRVIEW AVENUE APPROXIMATELY 340 FEET FORM THE INTERSECTION OF FAIRVIEW AVENUE AND JELINCIC DRIVE, BRASS DISK IN MONUMENT WELL STAMPED "FAIR B 1954" ELEVATION: 496.27.

ELEVATION: 496.27

SHEET INDEX TITLE SHEET JOB # 1 & 2 C-3JOB # 3 C-4C-5JOB # 4 CURB PROFILES JOB # 5 JOB # 6, 7 & 8 JOB # 9, 10 & 11 JOB # 12, 13, 14 & 15 C-10 JOB # 16 & 17 JOB # 18 & 19 JOB # 20 JOB # 20 SECTIONS STA 0+70 TO 1+10 JOB # 20 SECTIONS STA 1+70 TO 3+13.10 JOB # 20 SECTIONS STA 3+70 TO 4+70 JOB # 20 SECTIONS STA 5+20 TO 6+20 JOB # 20 SECTIONS STA 6+70 JOB # 21

DETAÎLS

DETAILS

EROSION CONTROL PLAN
EROSION CONTROL DETAILS

C-20

No. 63127
Exp. 06-30-12

CIVIL

LAND SURVEYORS

CRAMENTO REGION

7 DOUGLAS BLVD, # 300

8EVILLE, CA 95661

(916)797-7363

CIVIL ENGINEERS · LAN
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DUSTRIAL PKWY WEST
3017 DOL
D, CALIFORNIA 94545
(P) (916

CIVIL ENGINE BAY AREA REGION 2495 INDUSTRIAL PKWY WEST HAYWARD, CALIFORNIA 94545 (P) (510) 887–4086 (F) (510) 887–3019

CIC DRIVE TOWNSHIP

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TITLE SHE

C-1

1 OF 22 SHEETS

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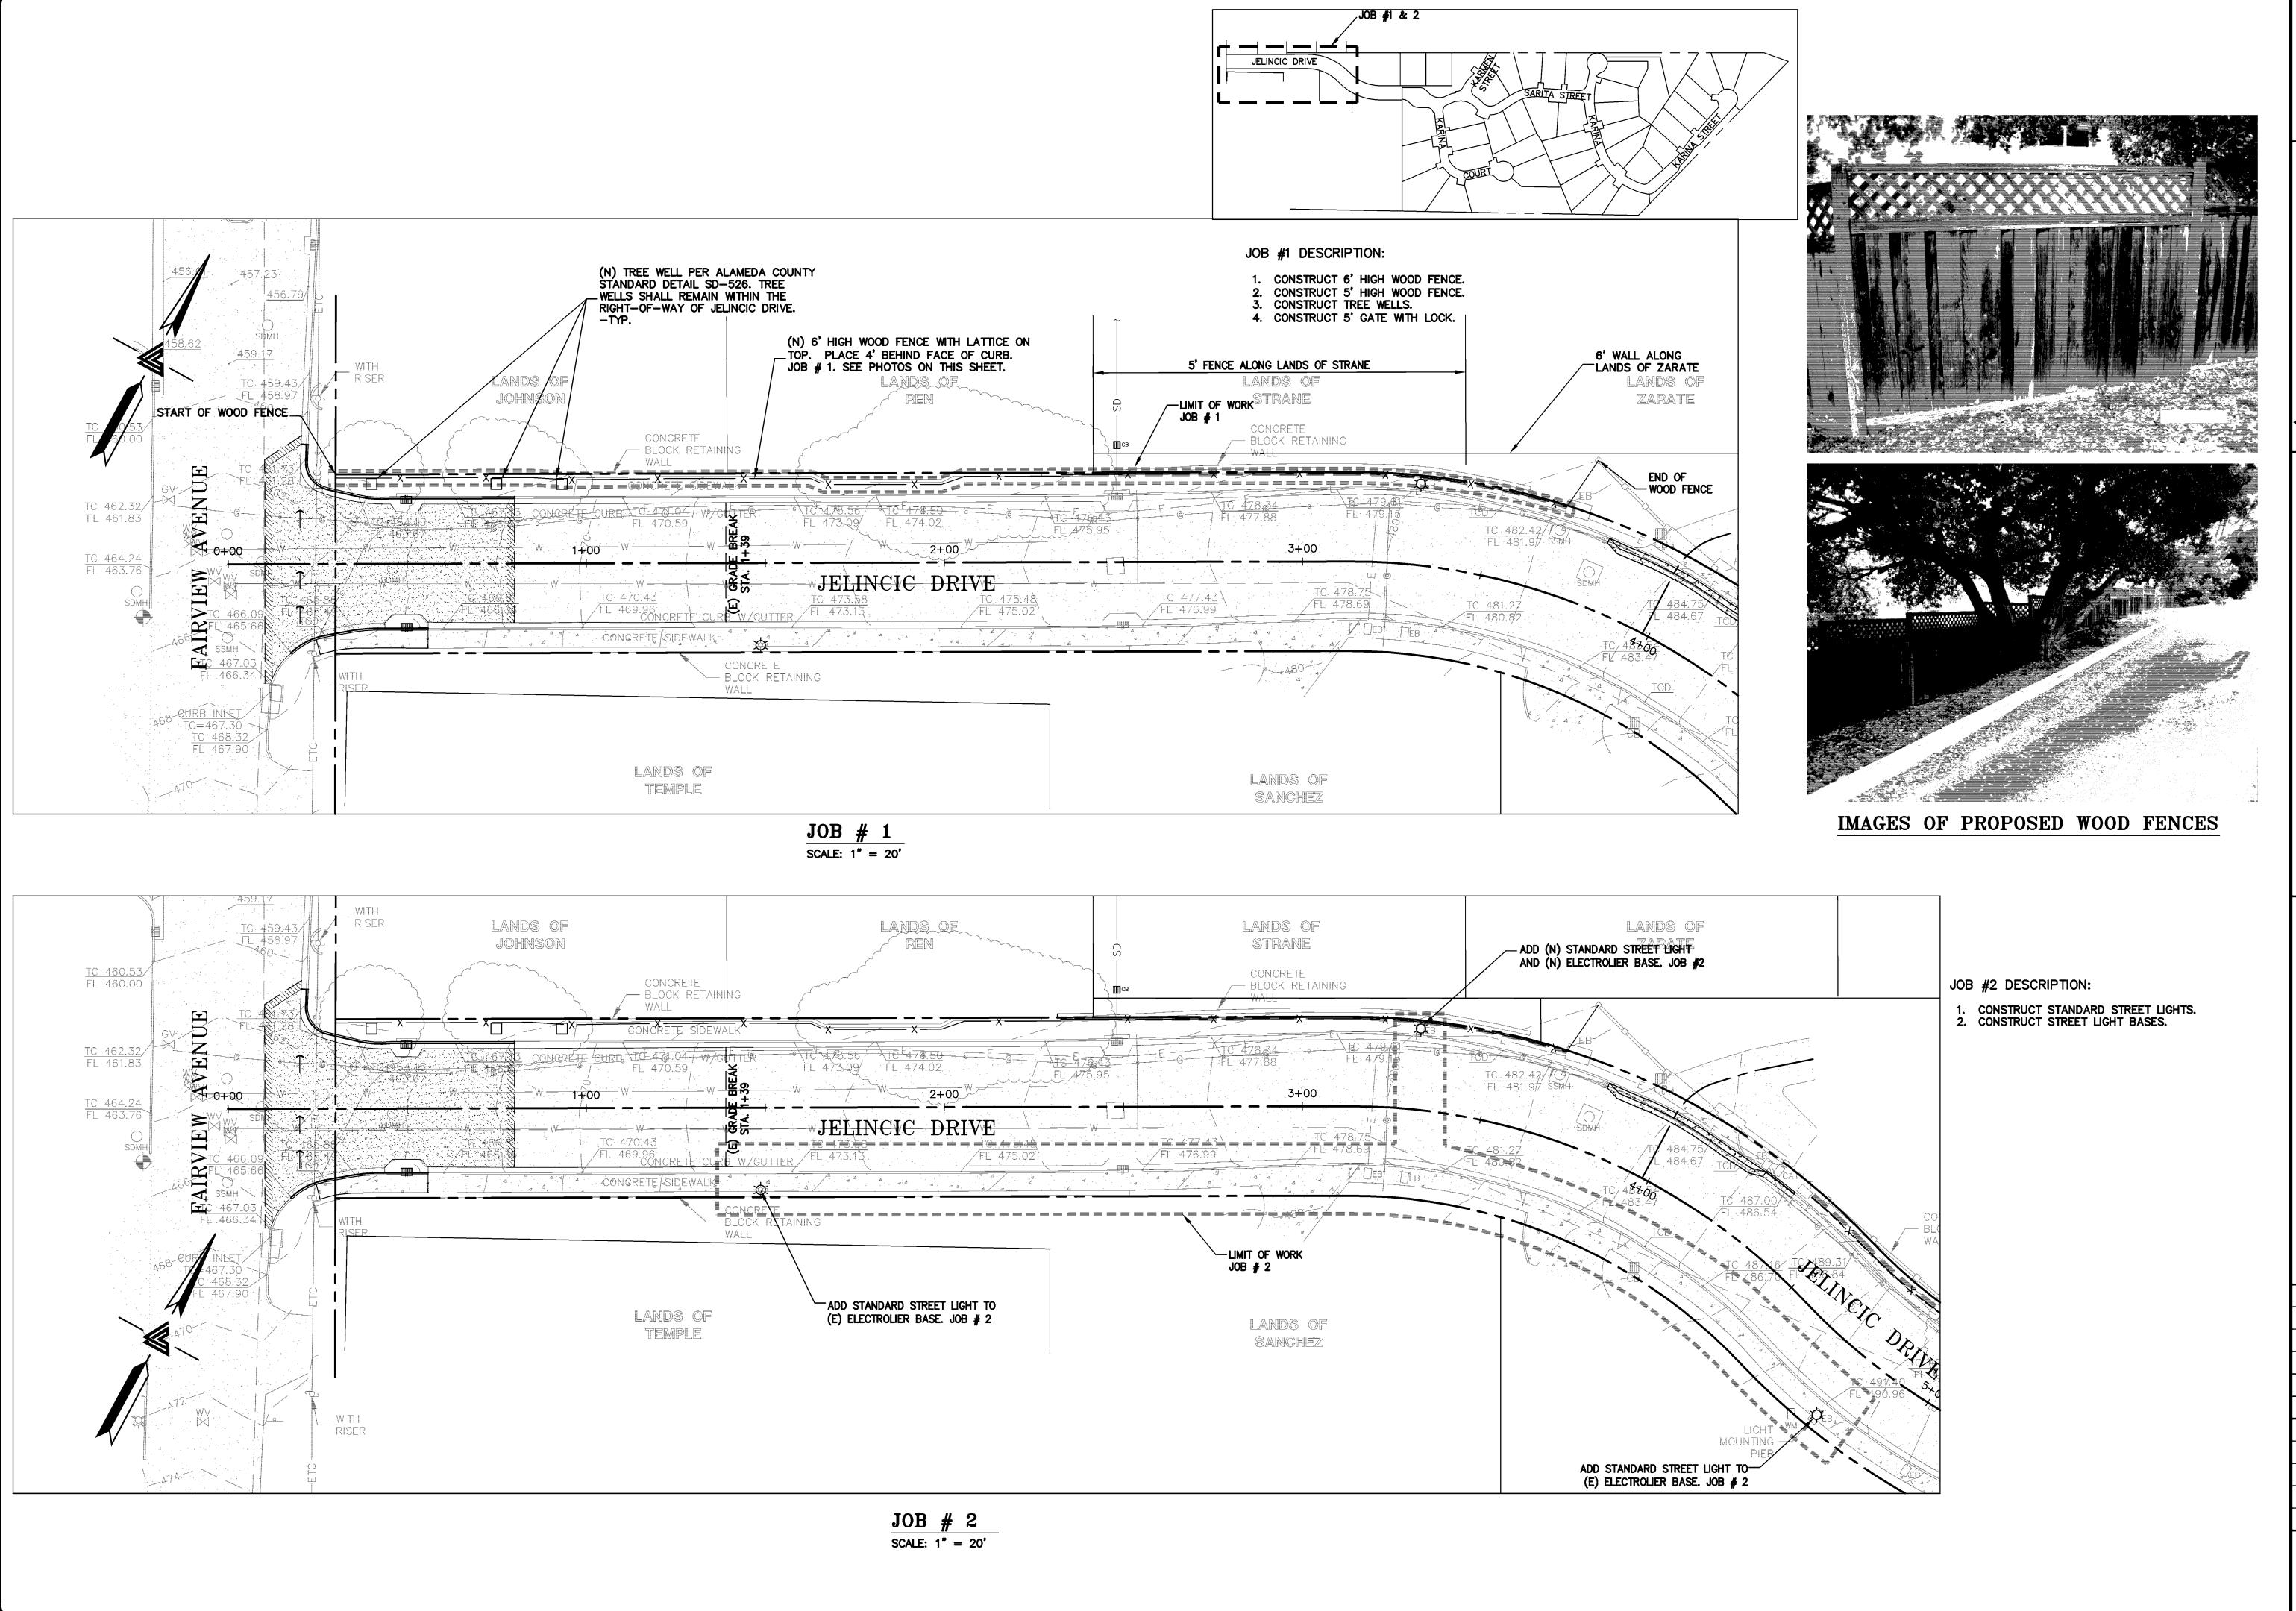
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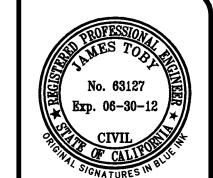
NOTE:
REPAIR AND REPLACE ANY AND
ALL BROKEN OR MALFUNCTIONING
STREET LIGHTS THROUGHOUT THE
DEVELOPMENT AS REQUIRED.

NOTE:
ANY RIGHT-OF-WAY DEDICATION RELOCATION
OF IMPROVEMENT OR PUBLIC FACILITIES, OR
ROAD IMPROVEMENTS SHALL BE ACCOMPLISHED
AT NO EXPENSE TO THE COUNTY.



NOTE:
FOR CONSTRUCTION STAKING
SCHEDULING OR QUOTATIONS
PLEASE CONTACT GREG BRAZE
AT LEA & BRAZE ENGINEERING
(510)887-4086 EXT 103.
gbraze@leabraze.com





NEERS · LAND SURVEYORS
SACRAMENTO REGION
SACRAMENTO REGION
SAT DOUGLAS BLVD, # 300
S45
(P) (916)966-1338

CIVIL ENGINEERS • LAN BAY AREA REGION 2495 INDUSTRIAL PKWY WEST 3017 DOL HAYWARD, CALIFORNIA 94545 ROSEVILI (P) (510) 887—4086 (F) (916 (F) (510) 887—3019 (F) (916

TRACT 6102 TELINCIC DRIVE DEN TOWNSHIP

JOB # 1 & 2

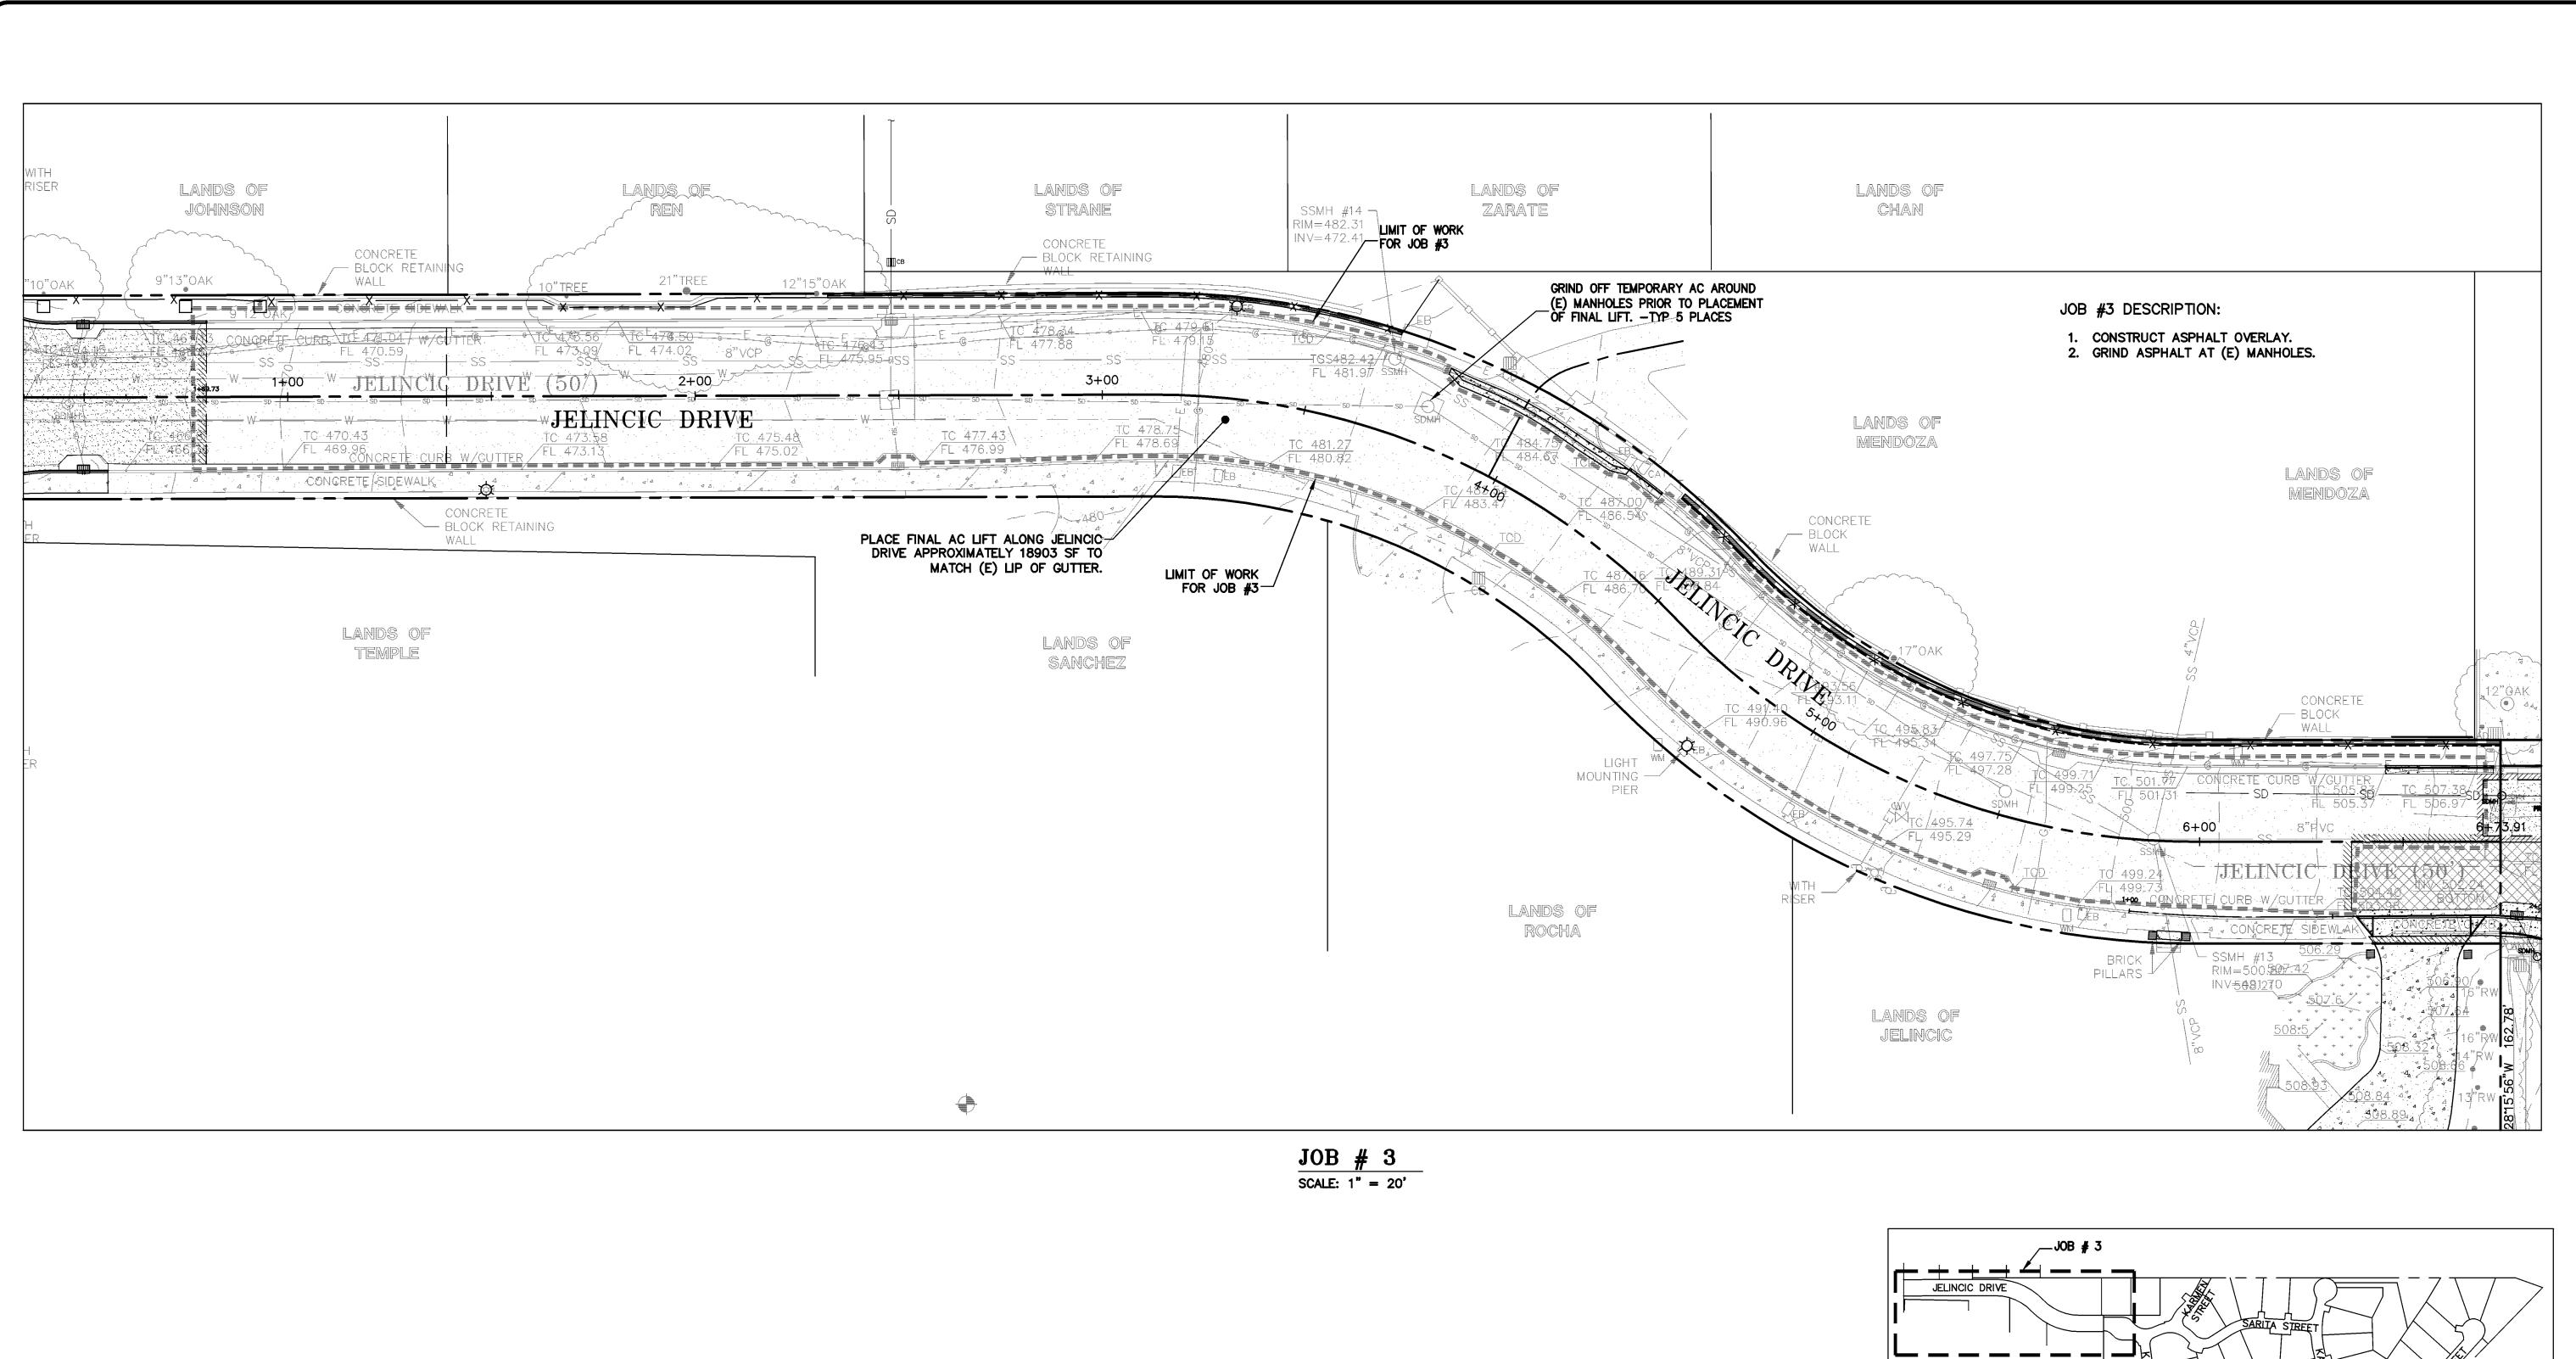
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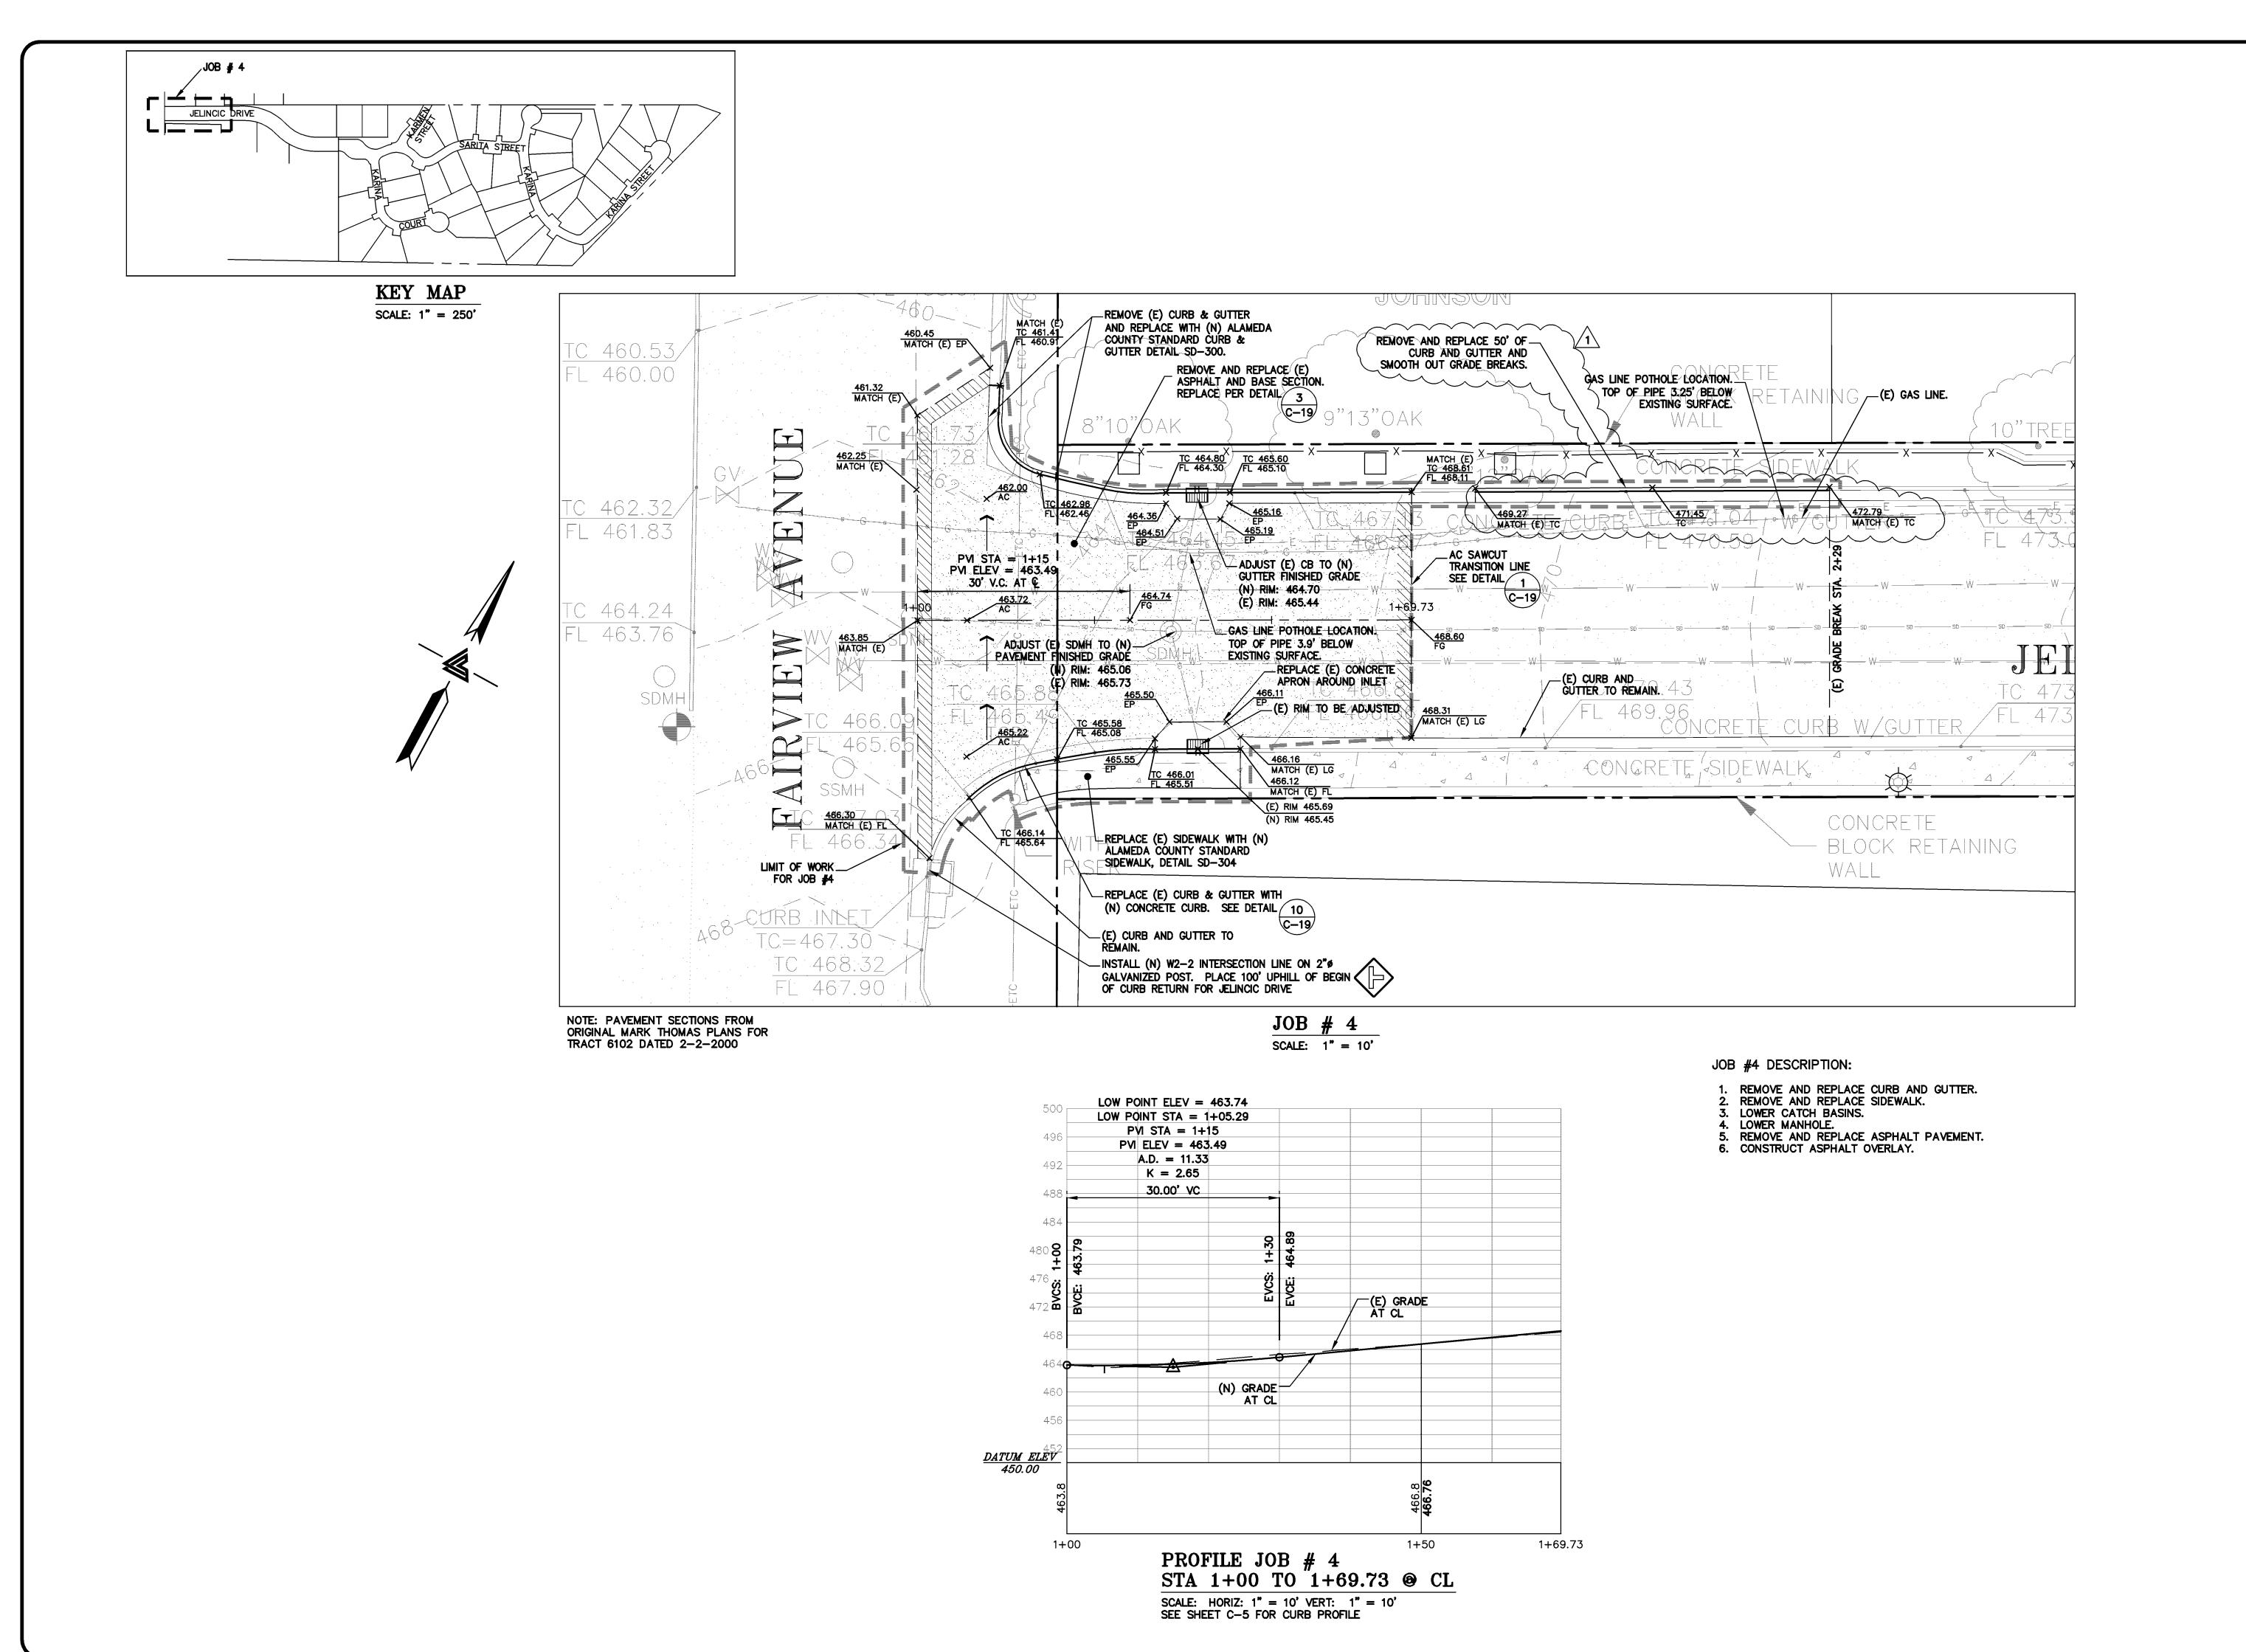


TRACT JELINCIC EDEN TOV

REVISIONS JOB NO: 2100094

AS NOTED DESIGN BY: JR/RC

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Exp. 06-30-12

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SACRAMENTO REGION
3017 DOUGLAS BLVD. # 300

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TRACT 6102 JELINCIC DRIVE EDEN TOWNSHIP

IOB # 4

 JOB NO:
 2100094

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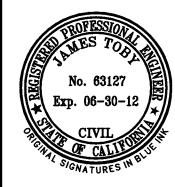
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1"=10' HOR & 1"=5' VERT



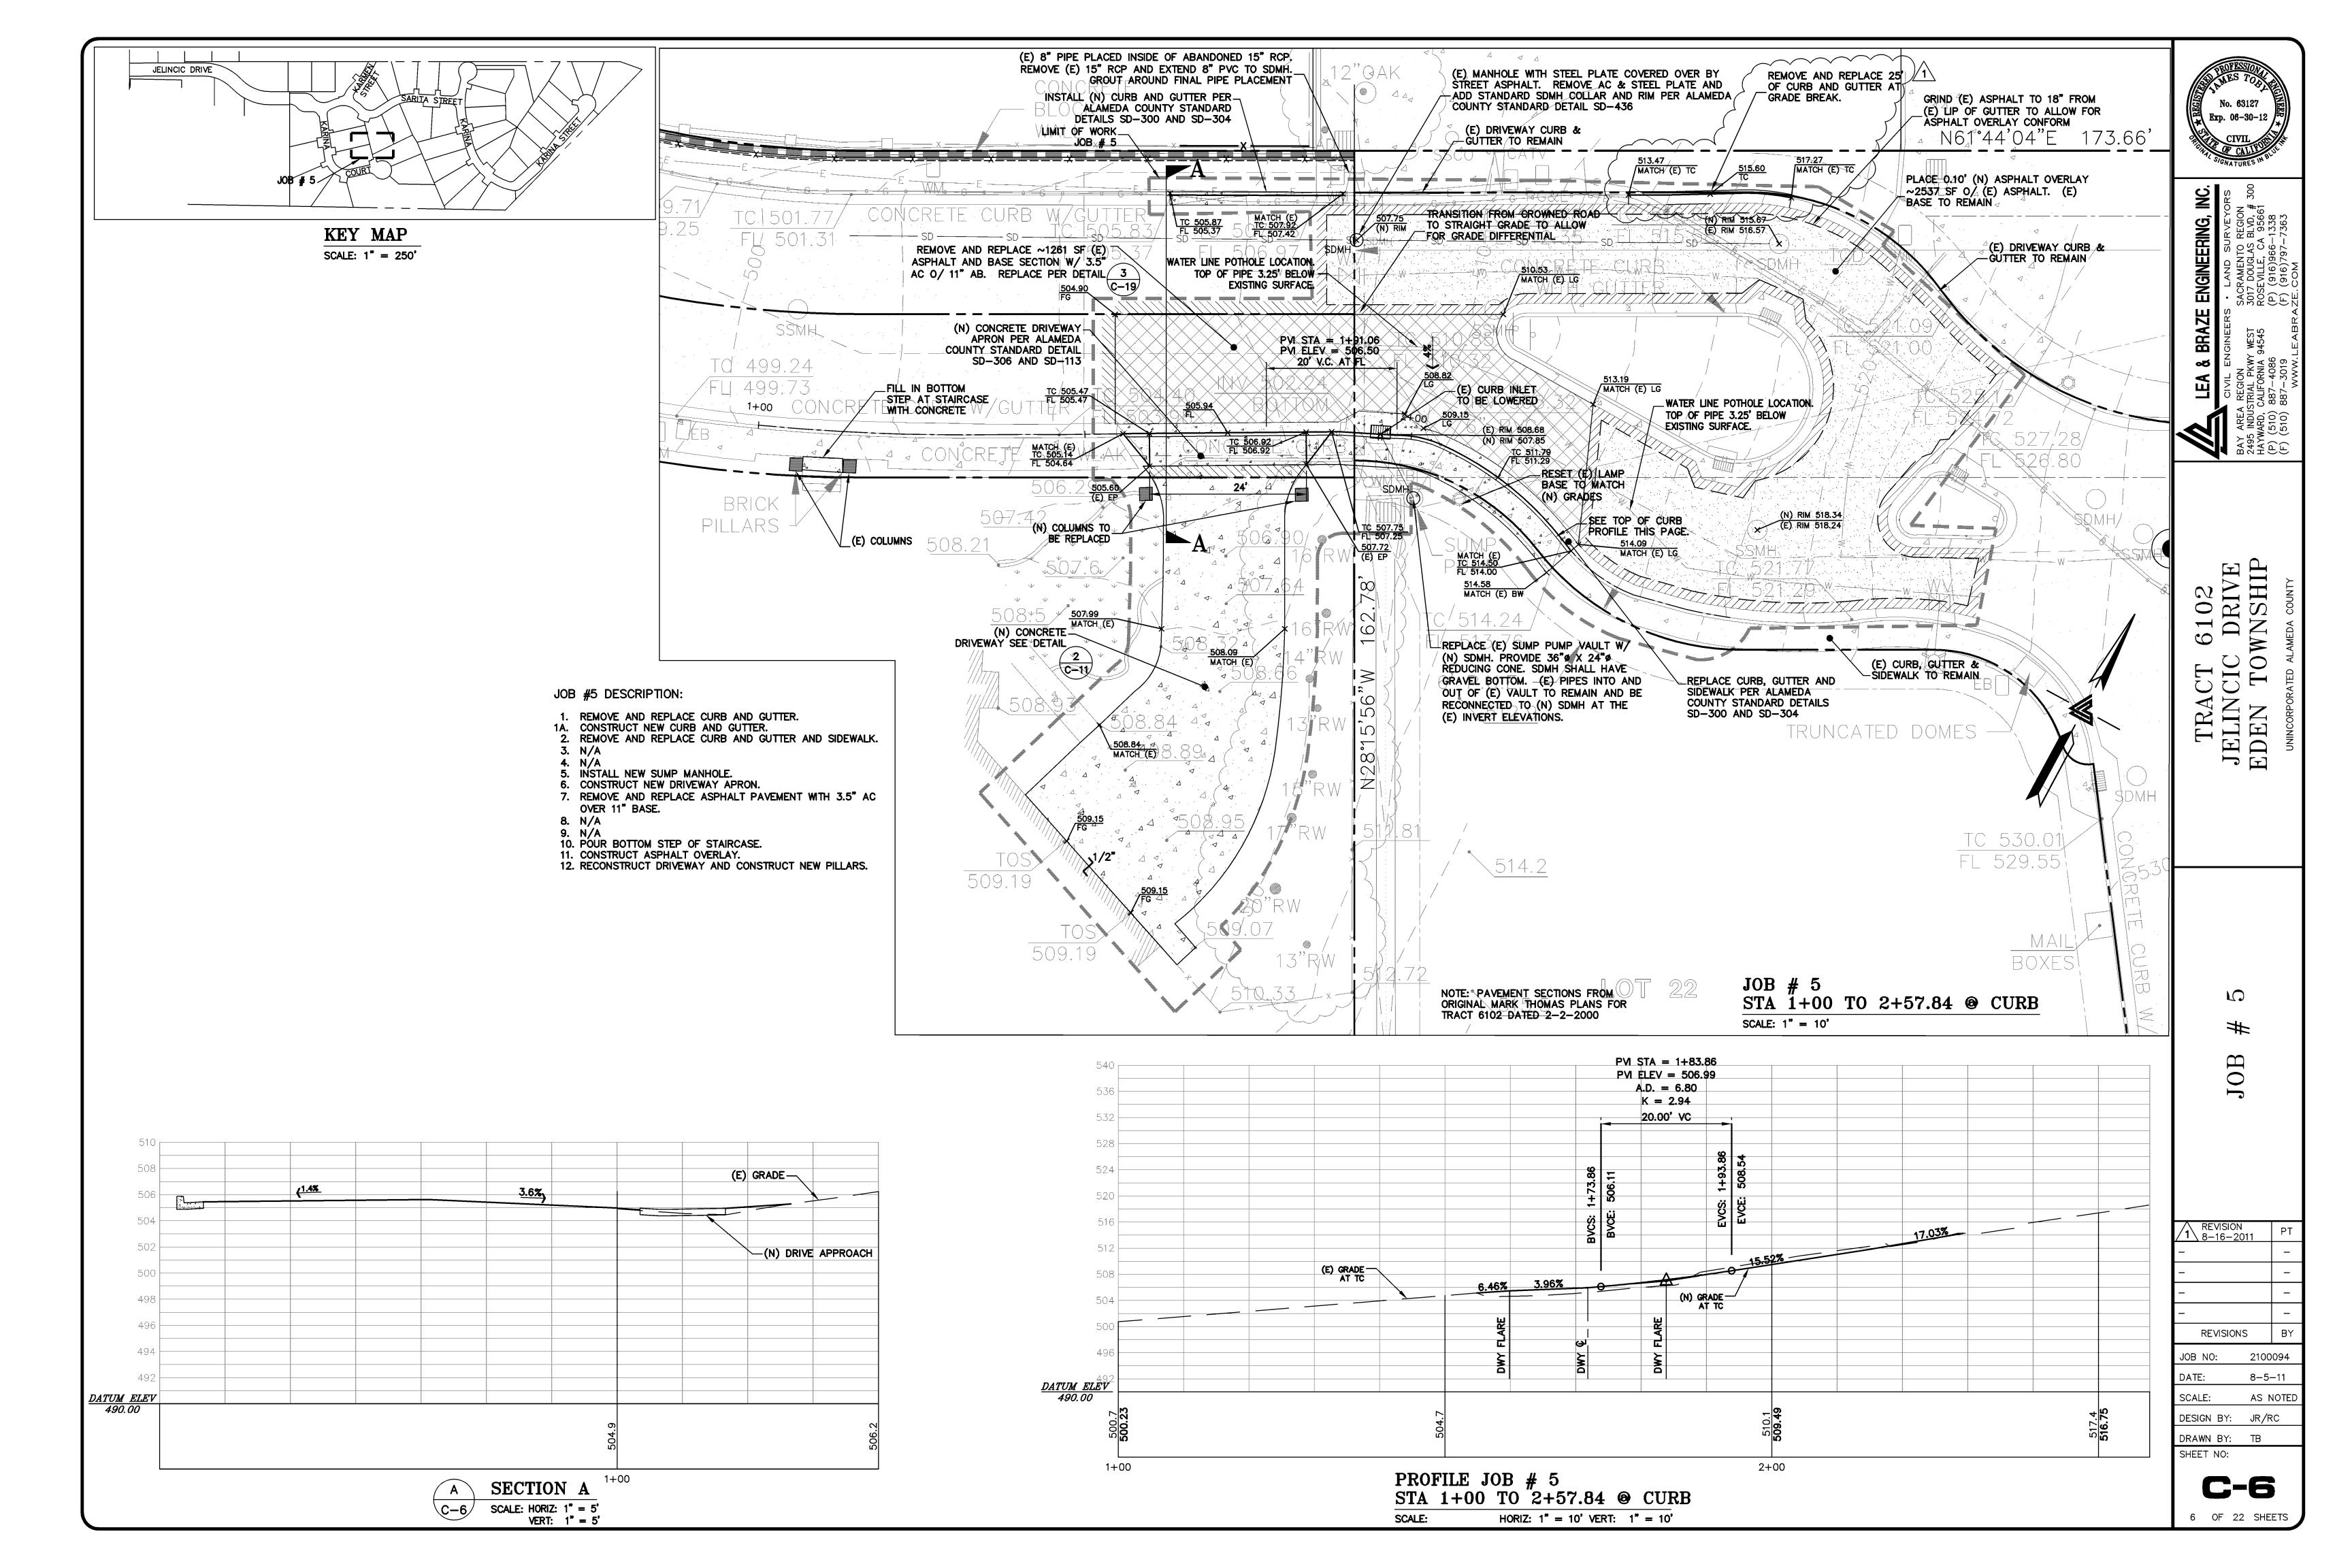
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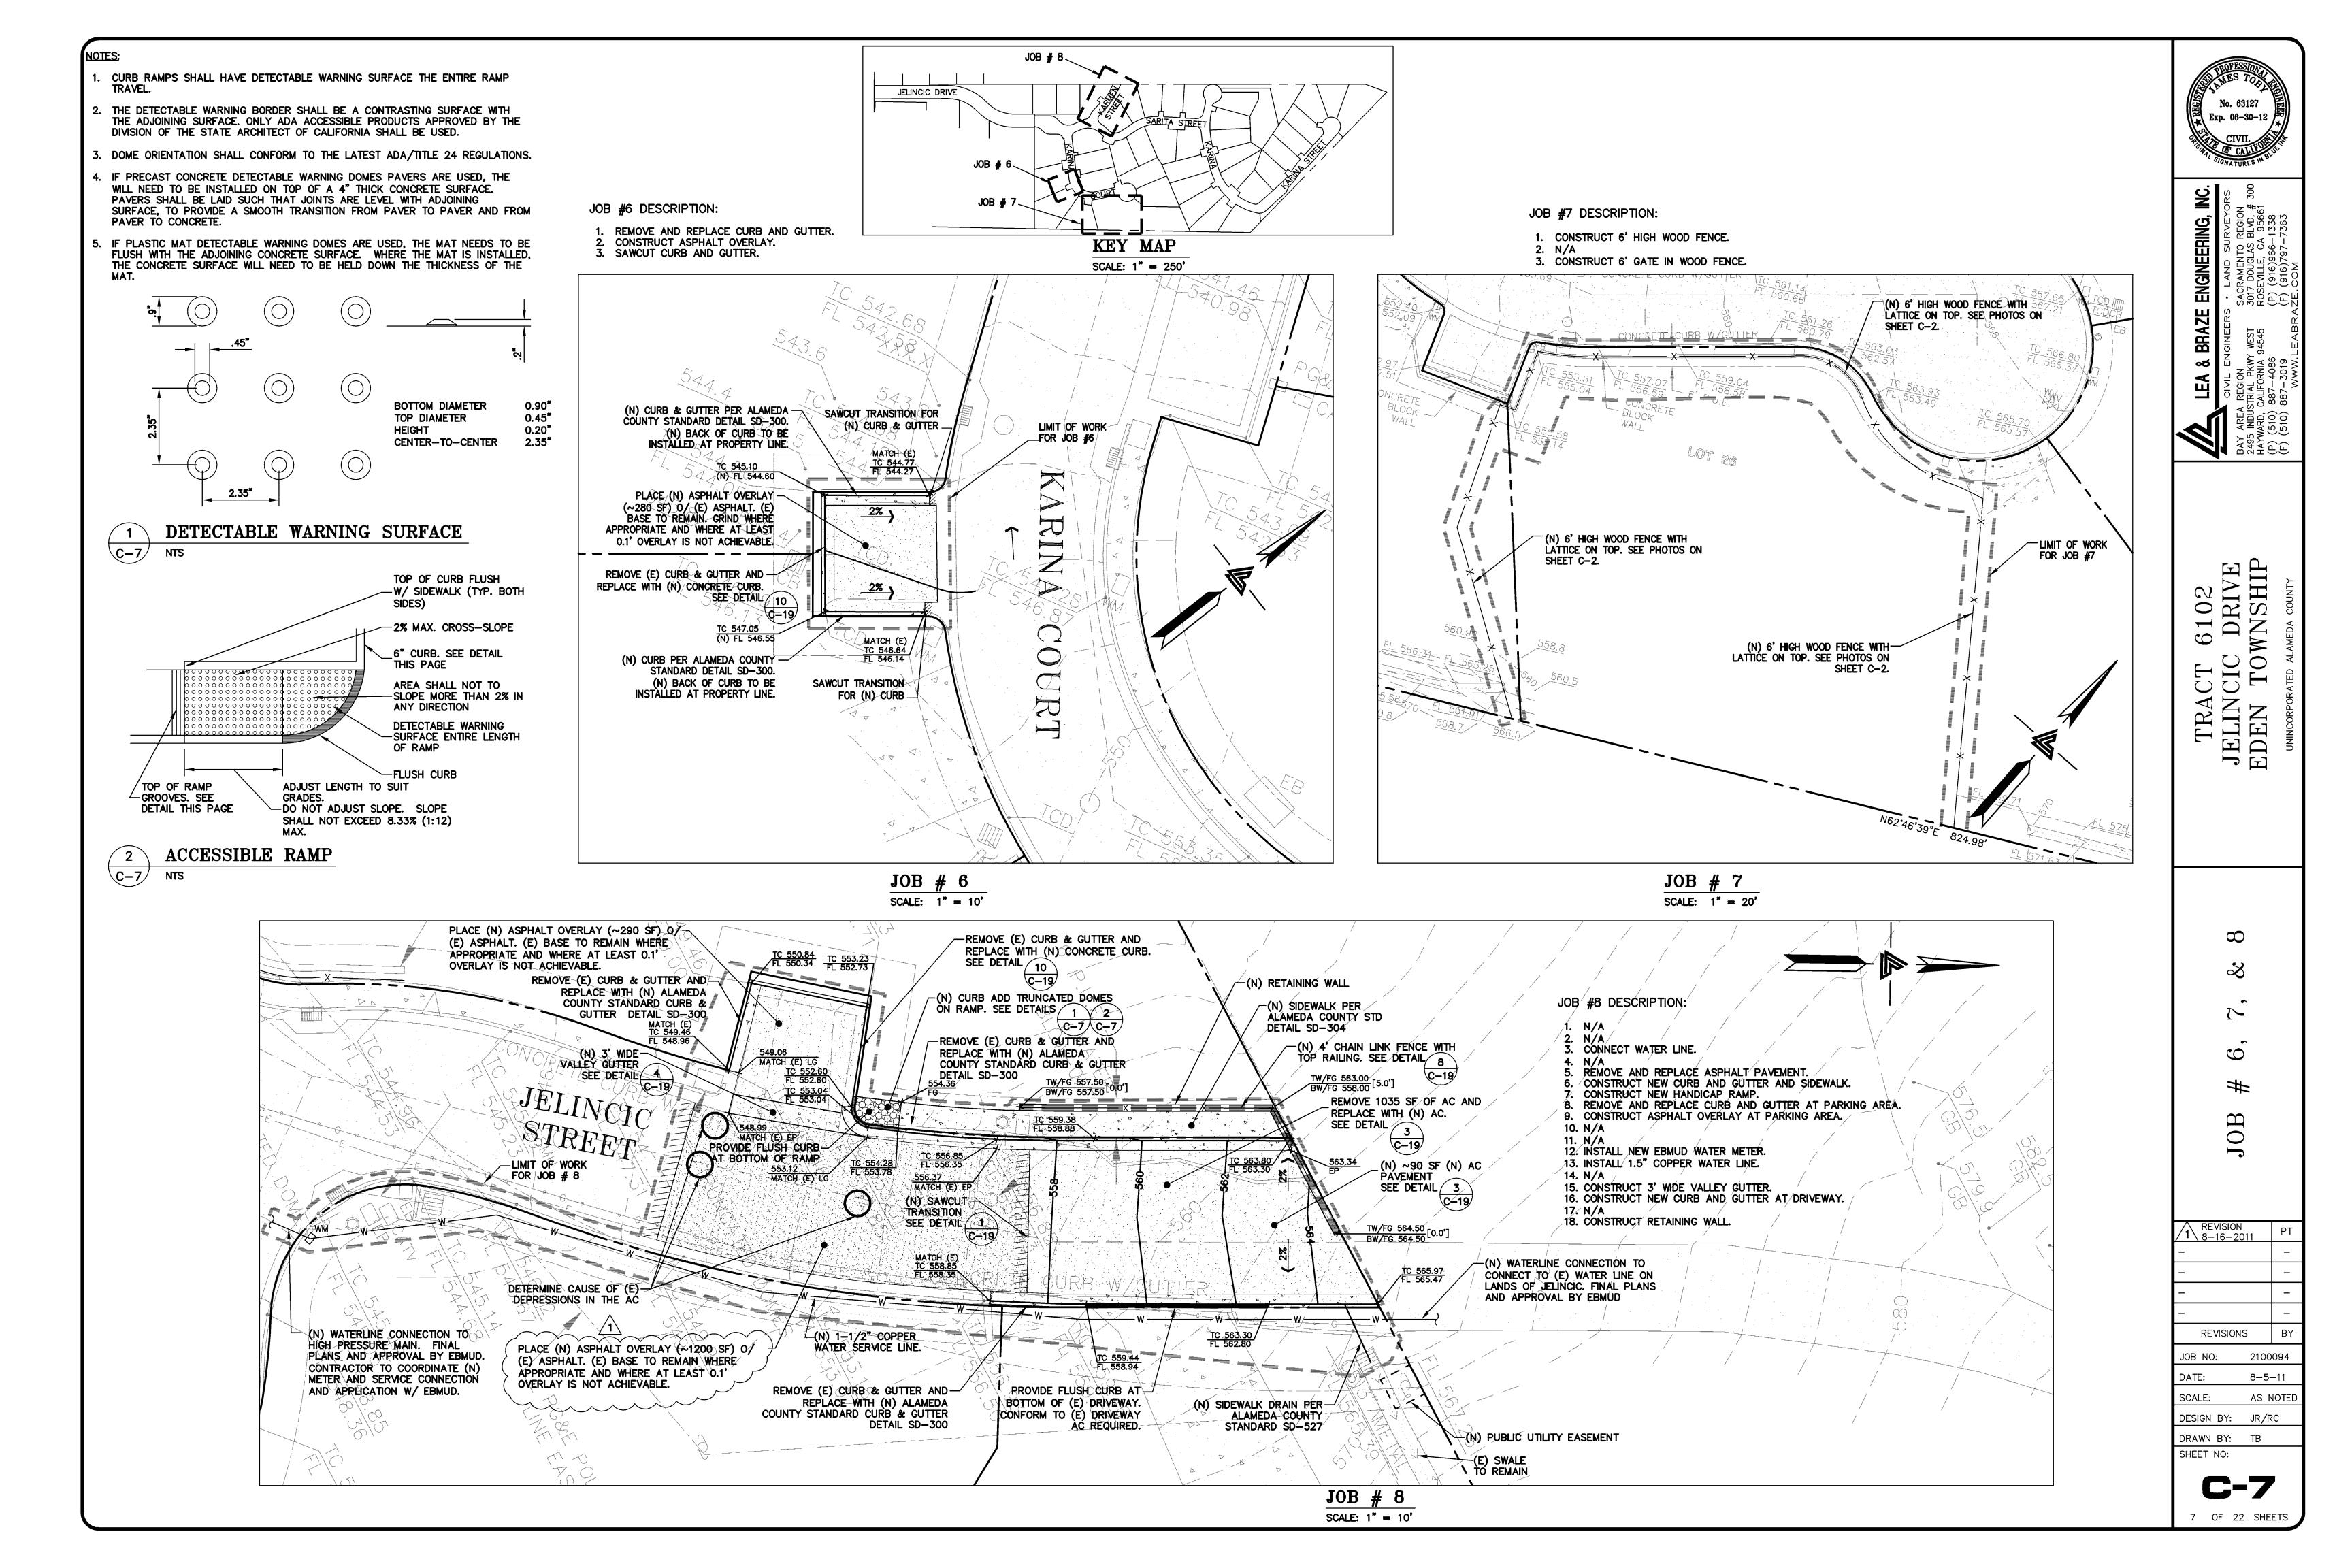
JELIN CURB

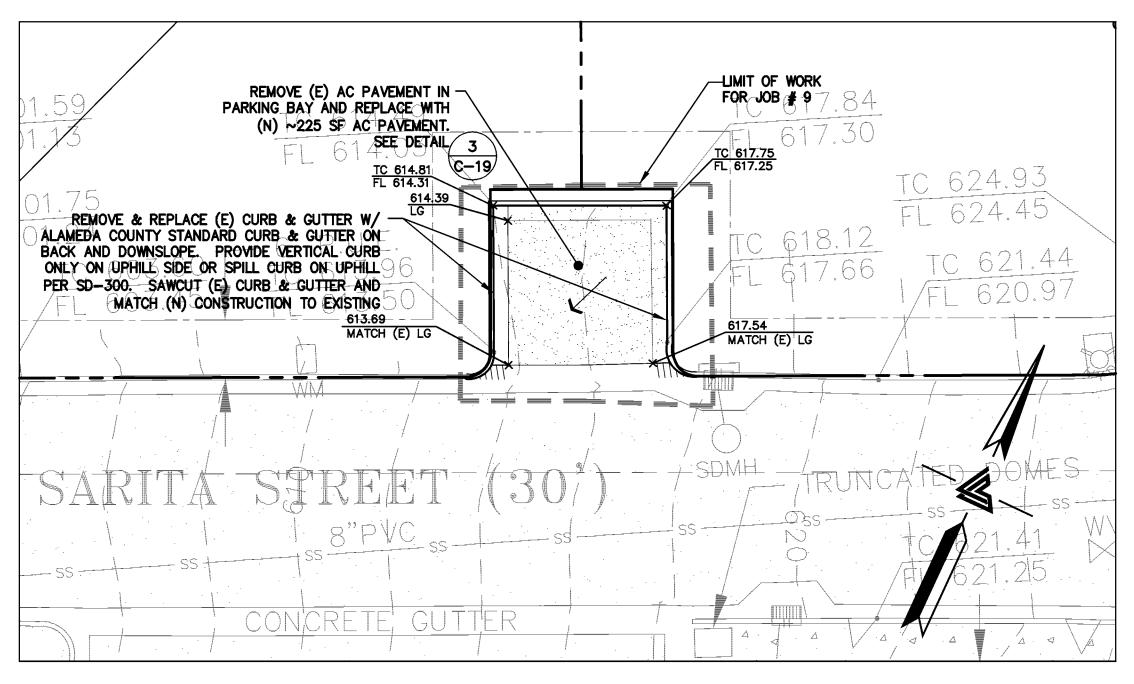
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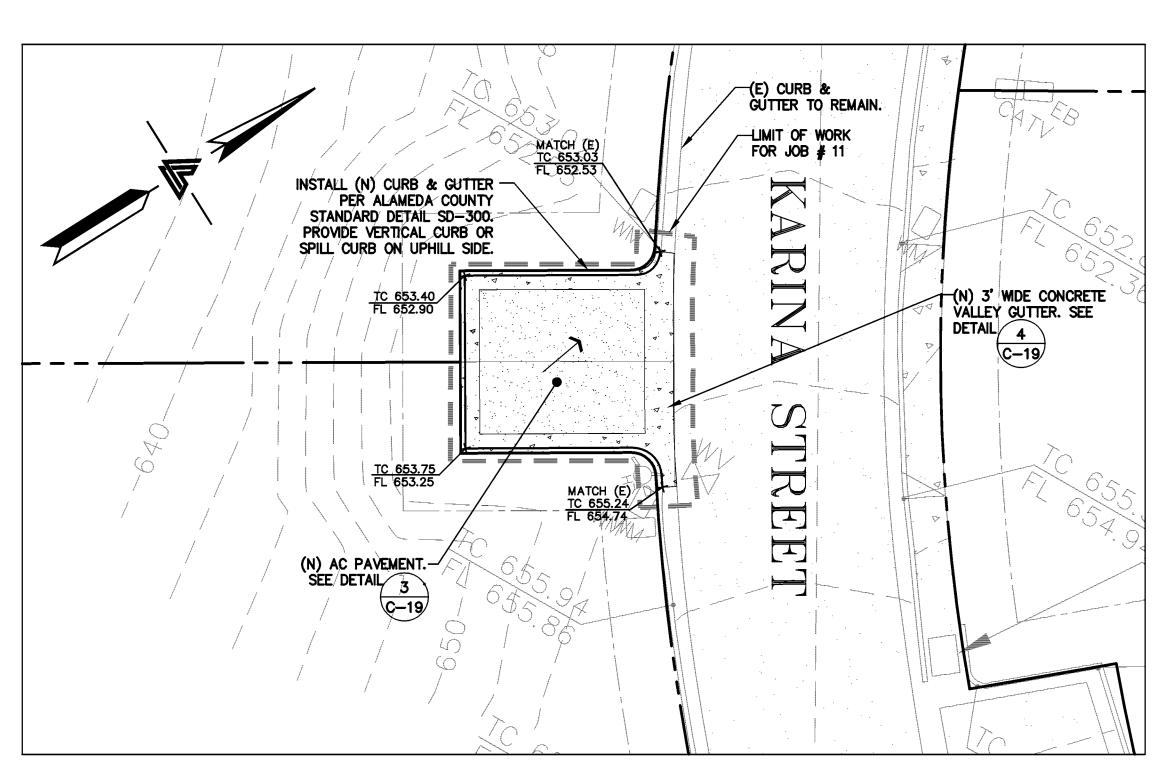




JOB #9 DESCRIPTION:

REMOVE AND REPLACE ASPHALT PAVEMENT.
 REMOVE AND REPLACE CURB AND GUTTER.

JOB # 9 SCALE: 1" = 10'



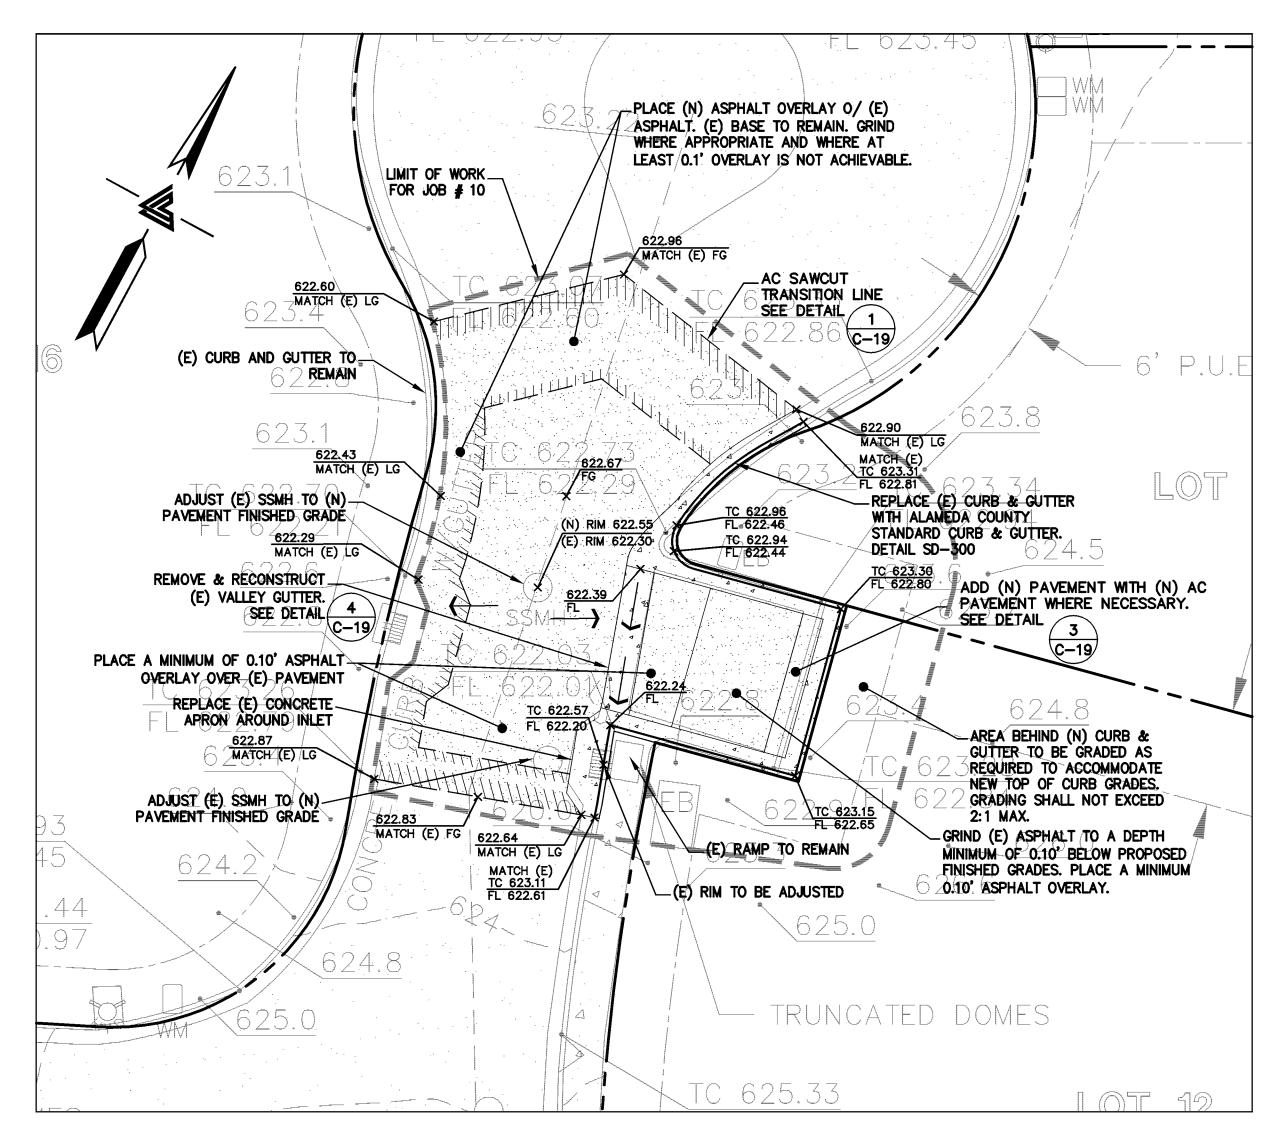
JOB # 10 SCALE: 1" = 10'

JOB #10 DESCRIPTION:

- REMOVE AND REPLACE CURB AND GUTTER.
 REMOVE AND REPLACE ASPHALT PAVEMENT.
 ADJUST EXISTING CATCH BASIN.
 ADJUST EXISTING MANHOLE.

- 5. REMOVE AND REPLACE VALLEY GUTTER.6. CONSTRUCT ASPHALT OVERLAY.

CONSTRUCT NEW CURB AND GUTTER.



JOB #11 DESCRIPTION:

2. CONSTRUCT NEW ASPHALT PAVEMENT. 3. CONSTRUCT NEW VALLEY GUTTER.

SHEET NO:

8 OF 22 SHEETS

DESIGN BY: JR/RC

DRAWN BY: TB

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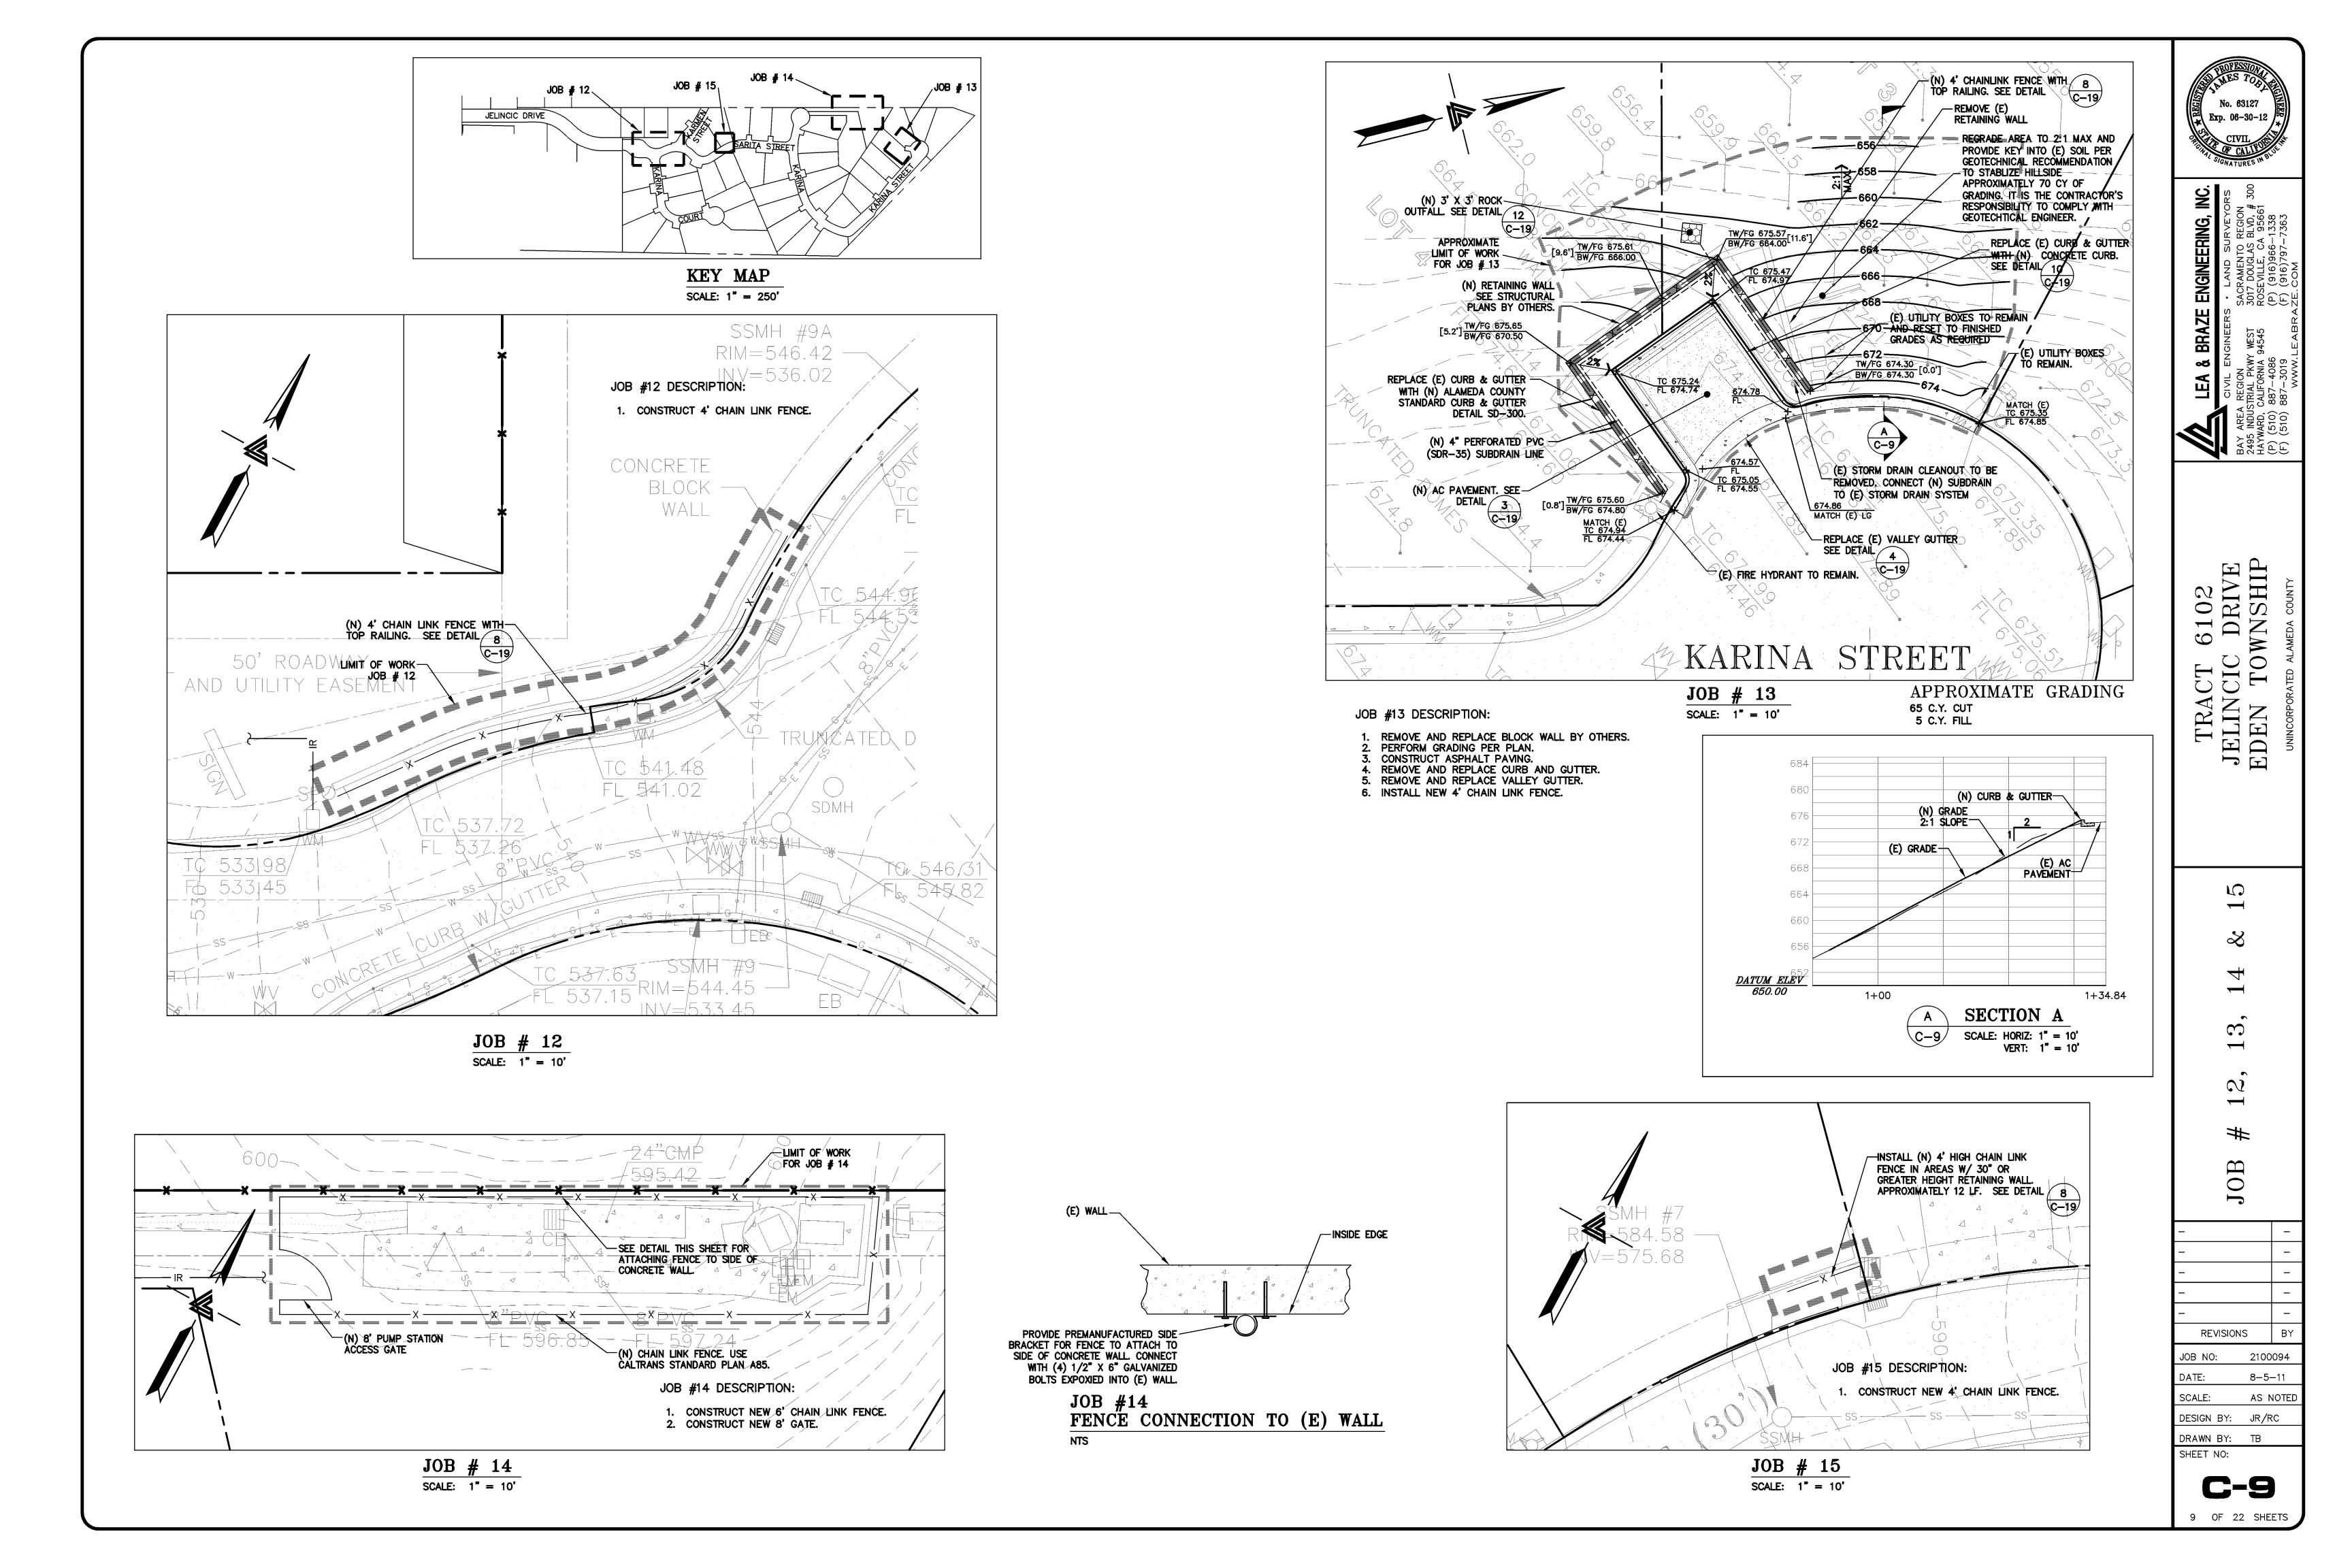
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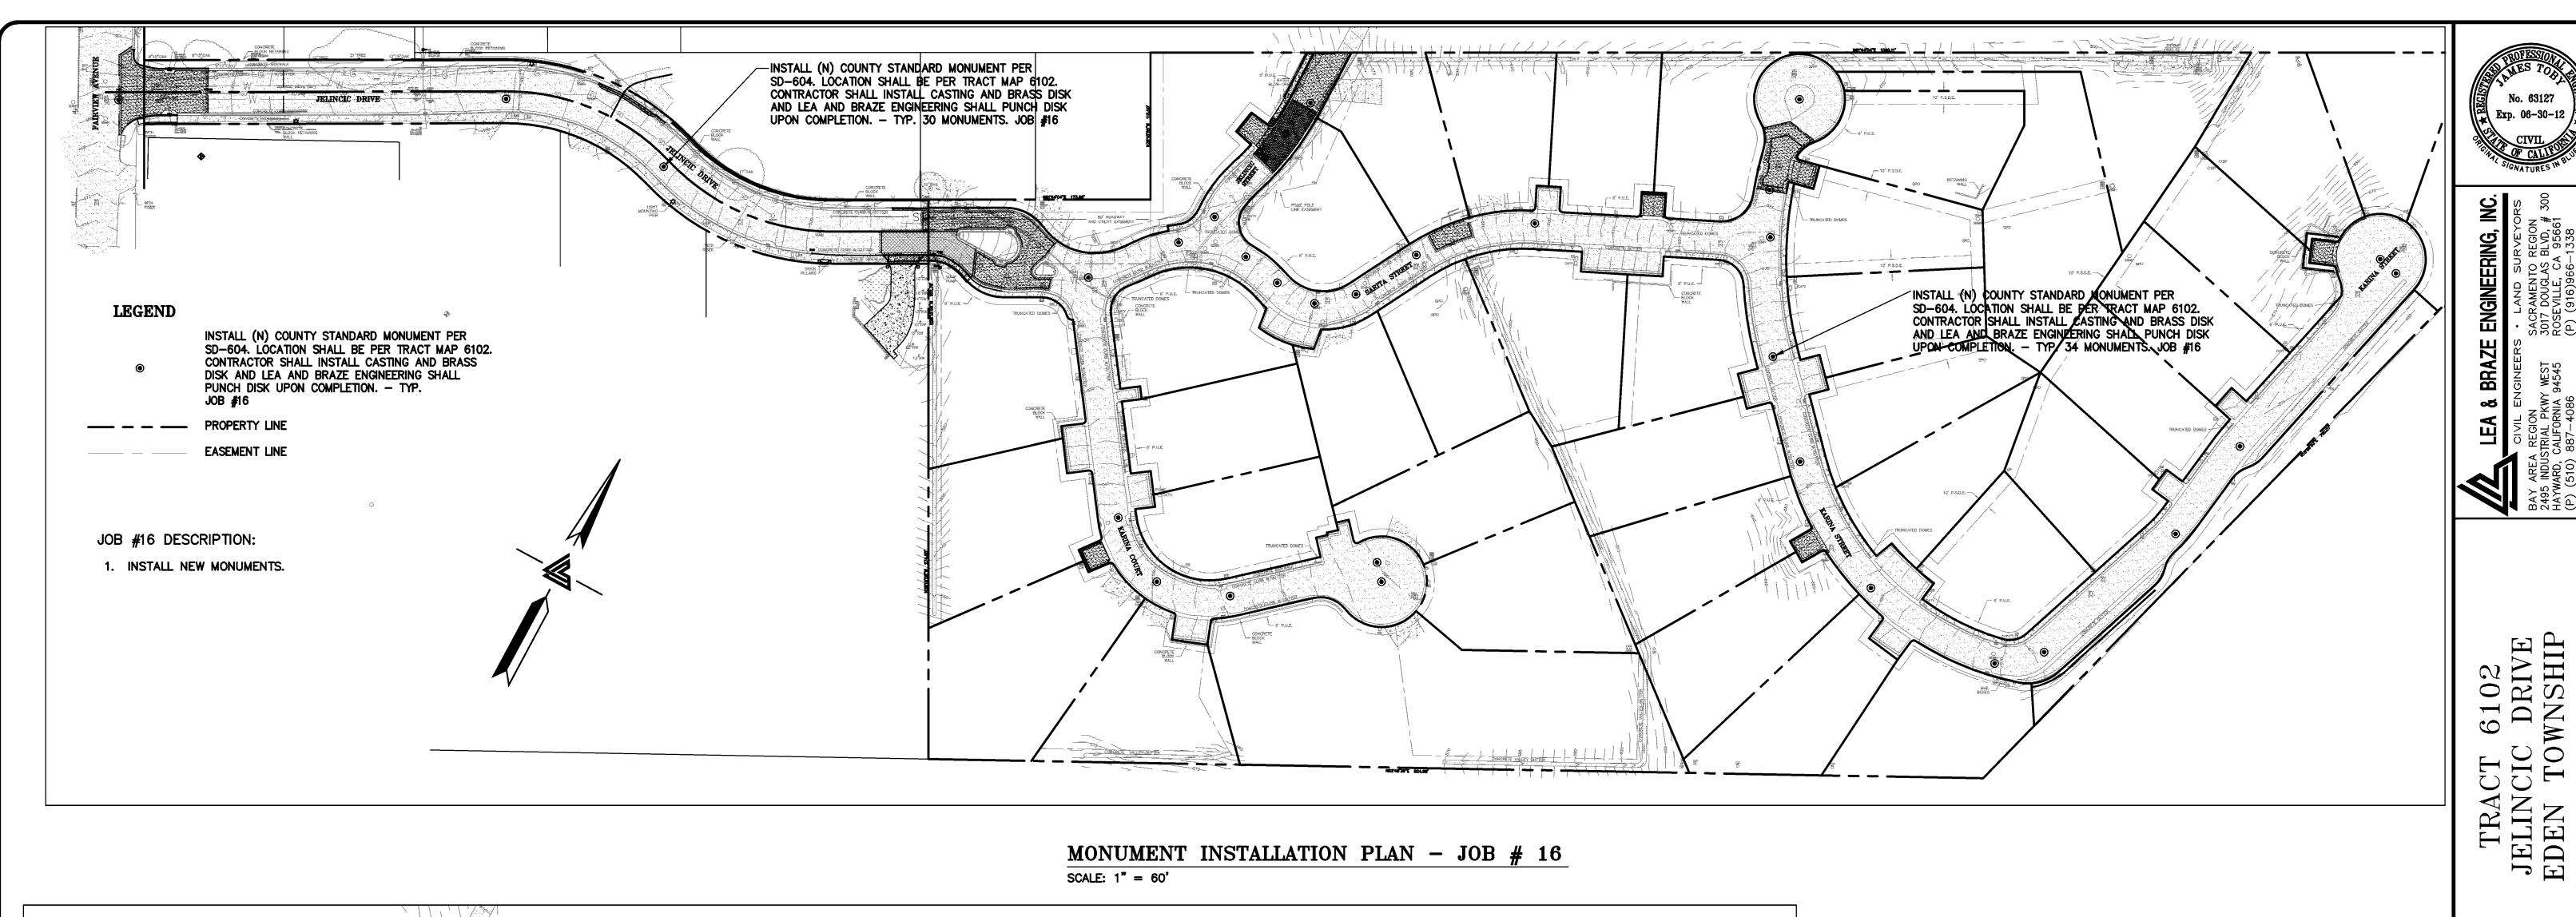
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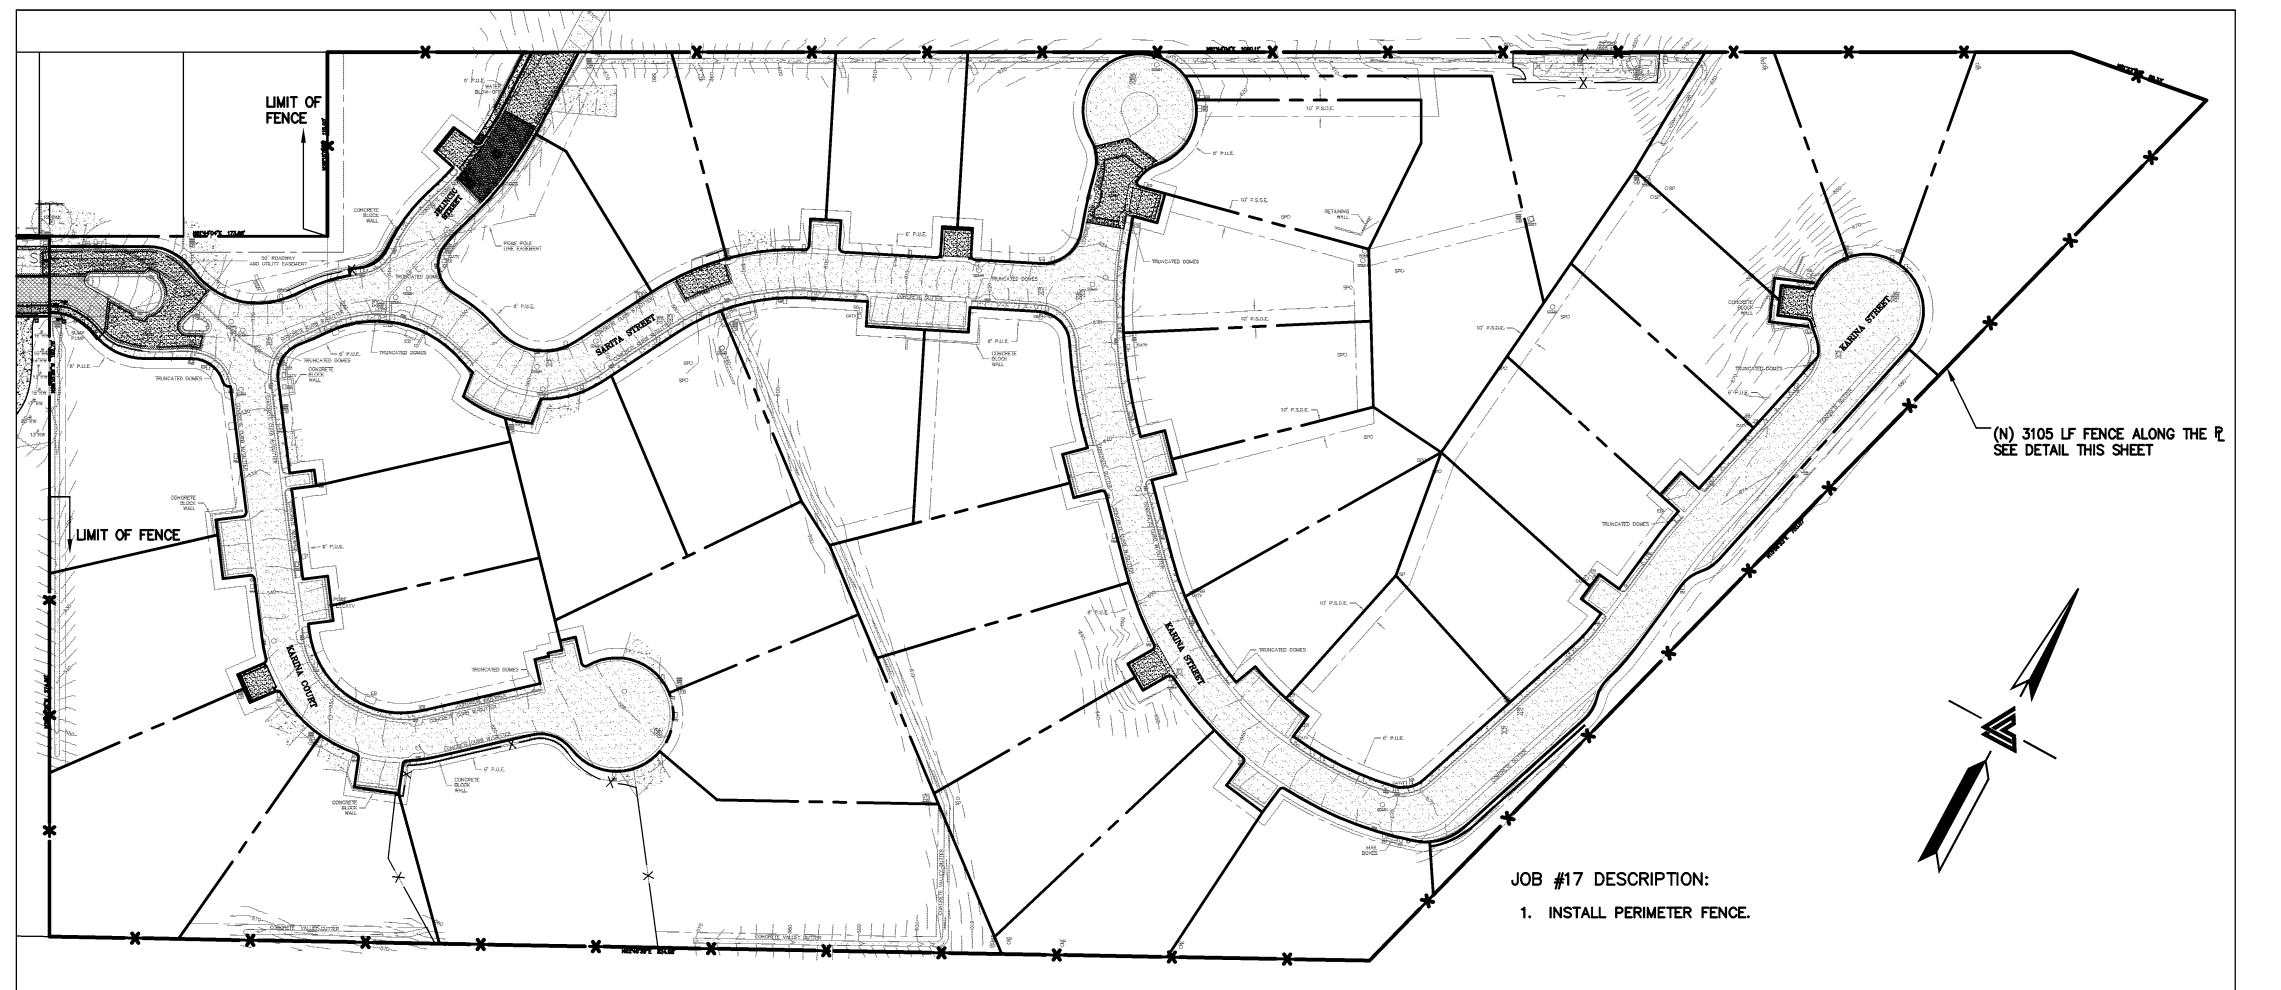
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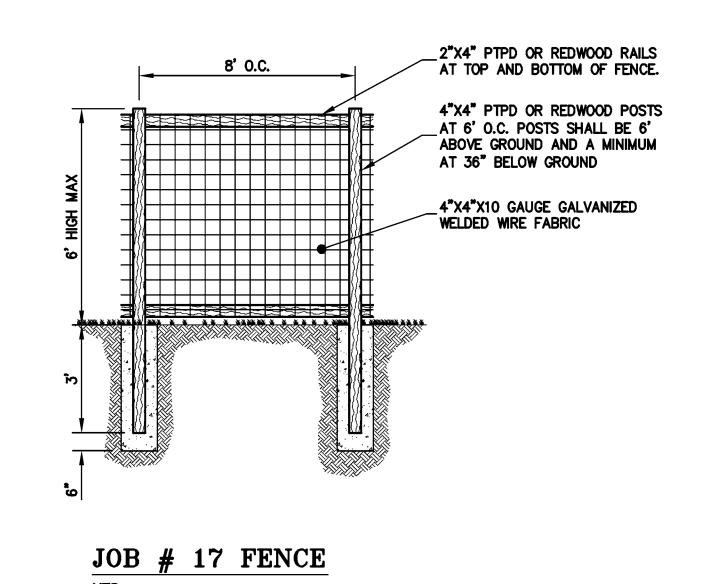
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JOB # 11 SCALE: 1" = 10'









JOB # 17
SCALE: 1" = 60'

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10 OF 22 SHEETS

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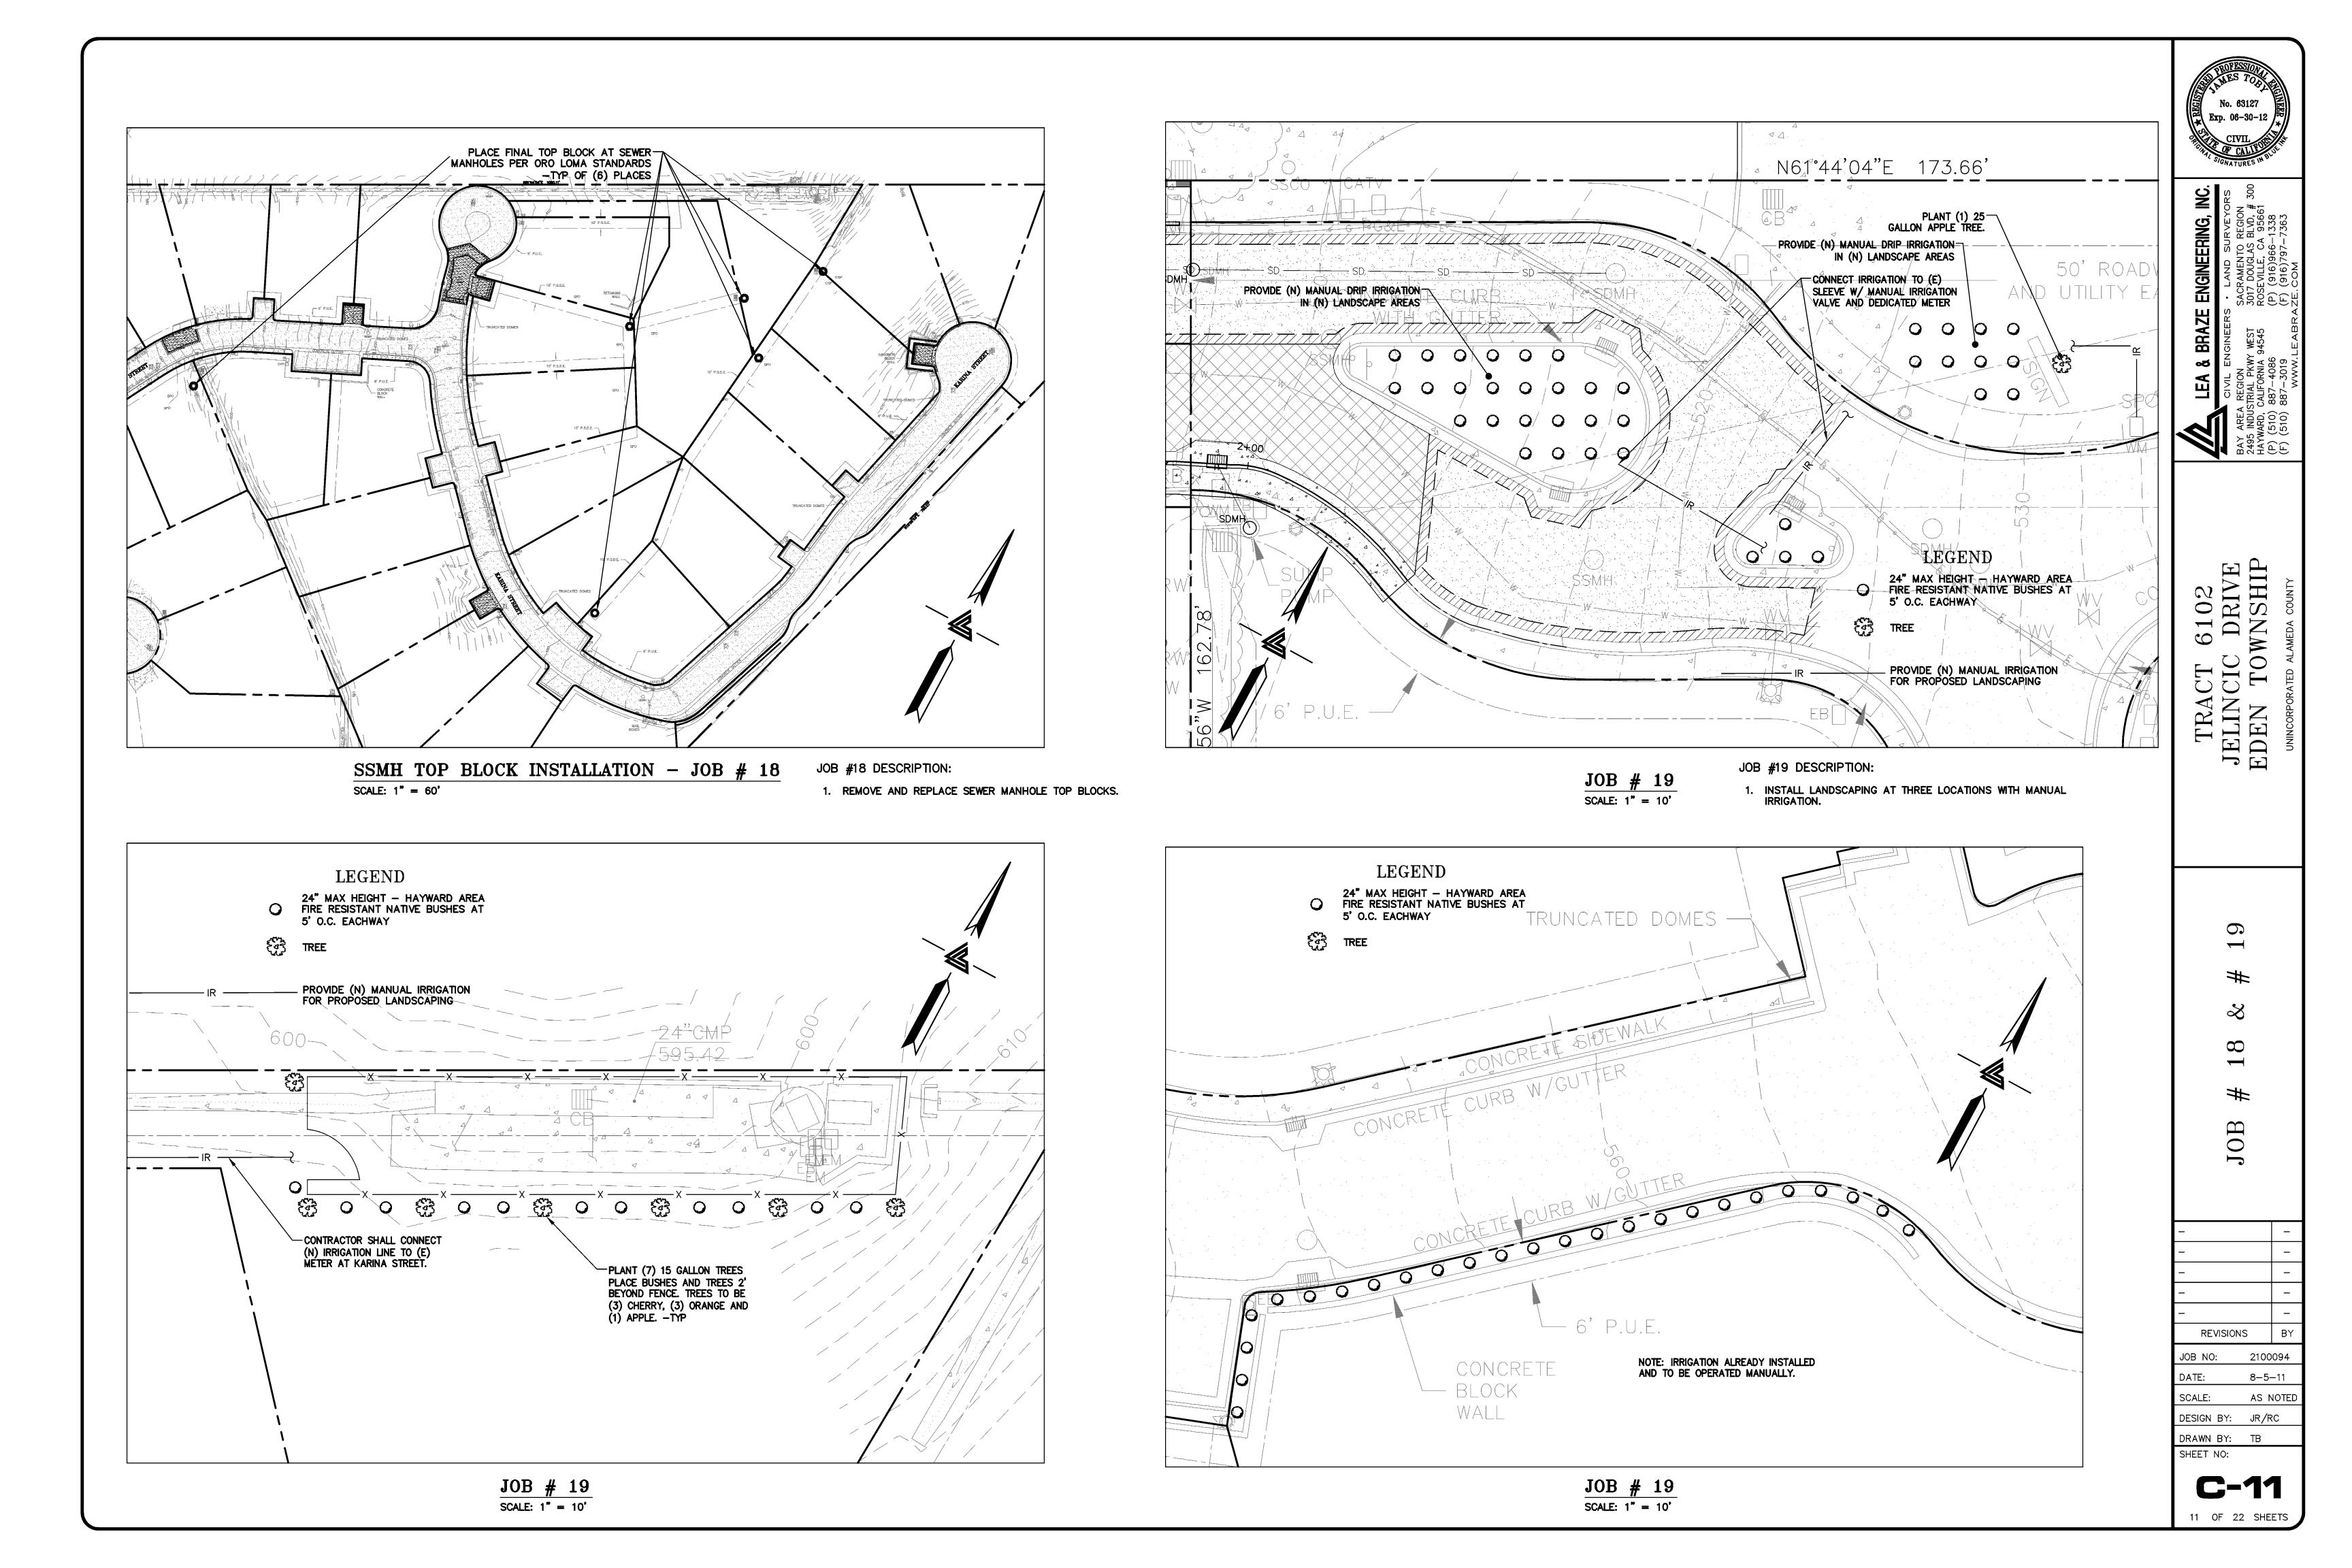
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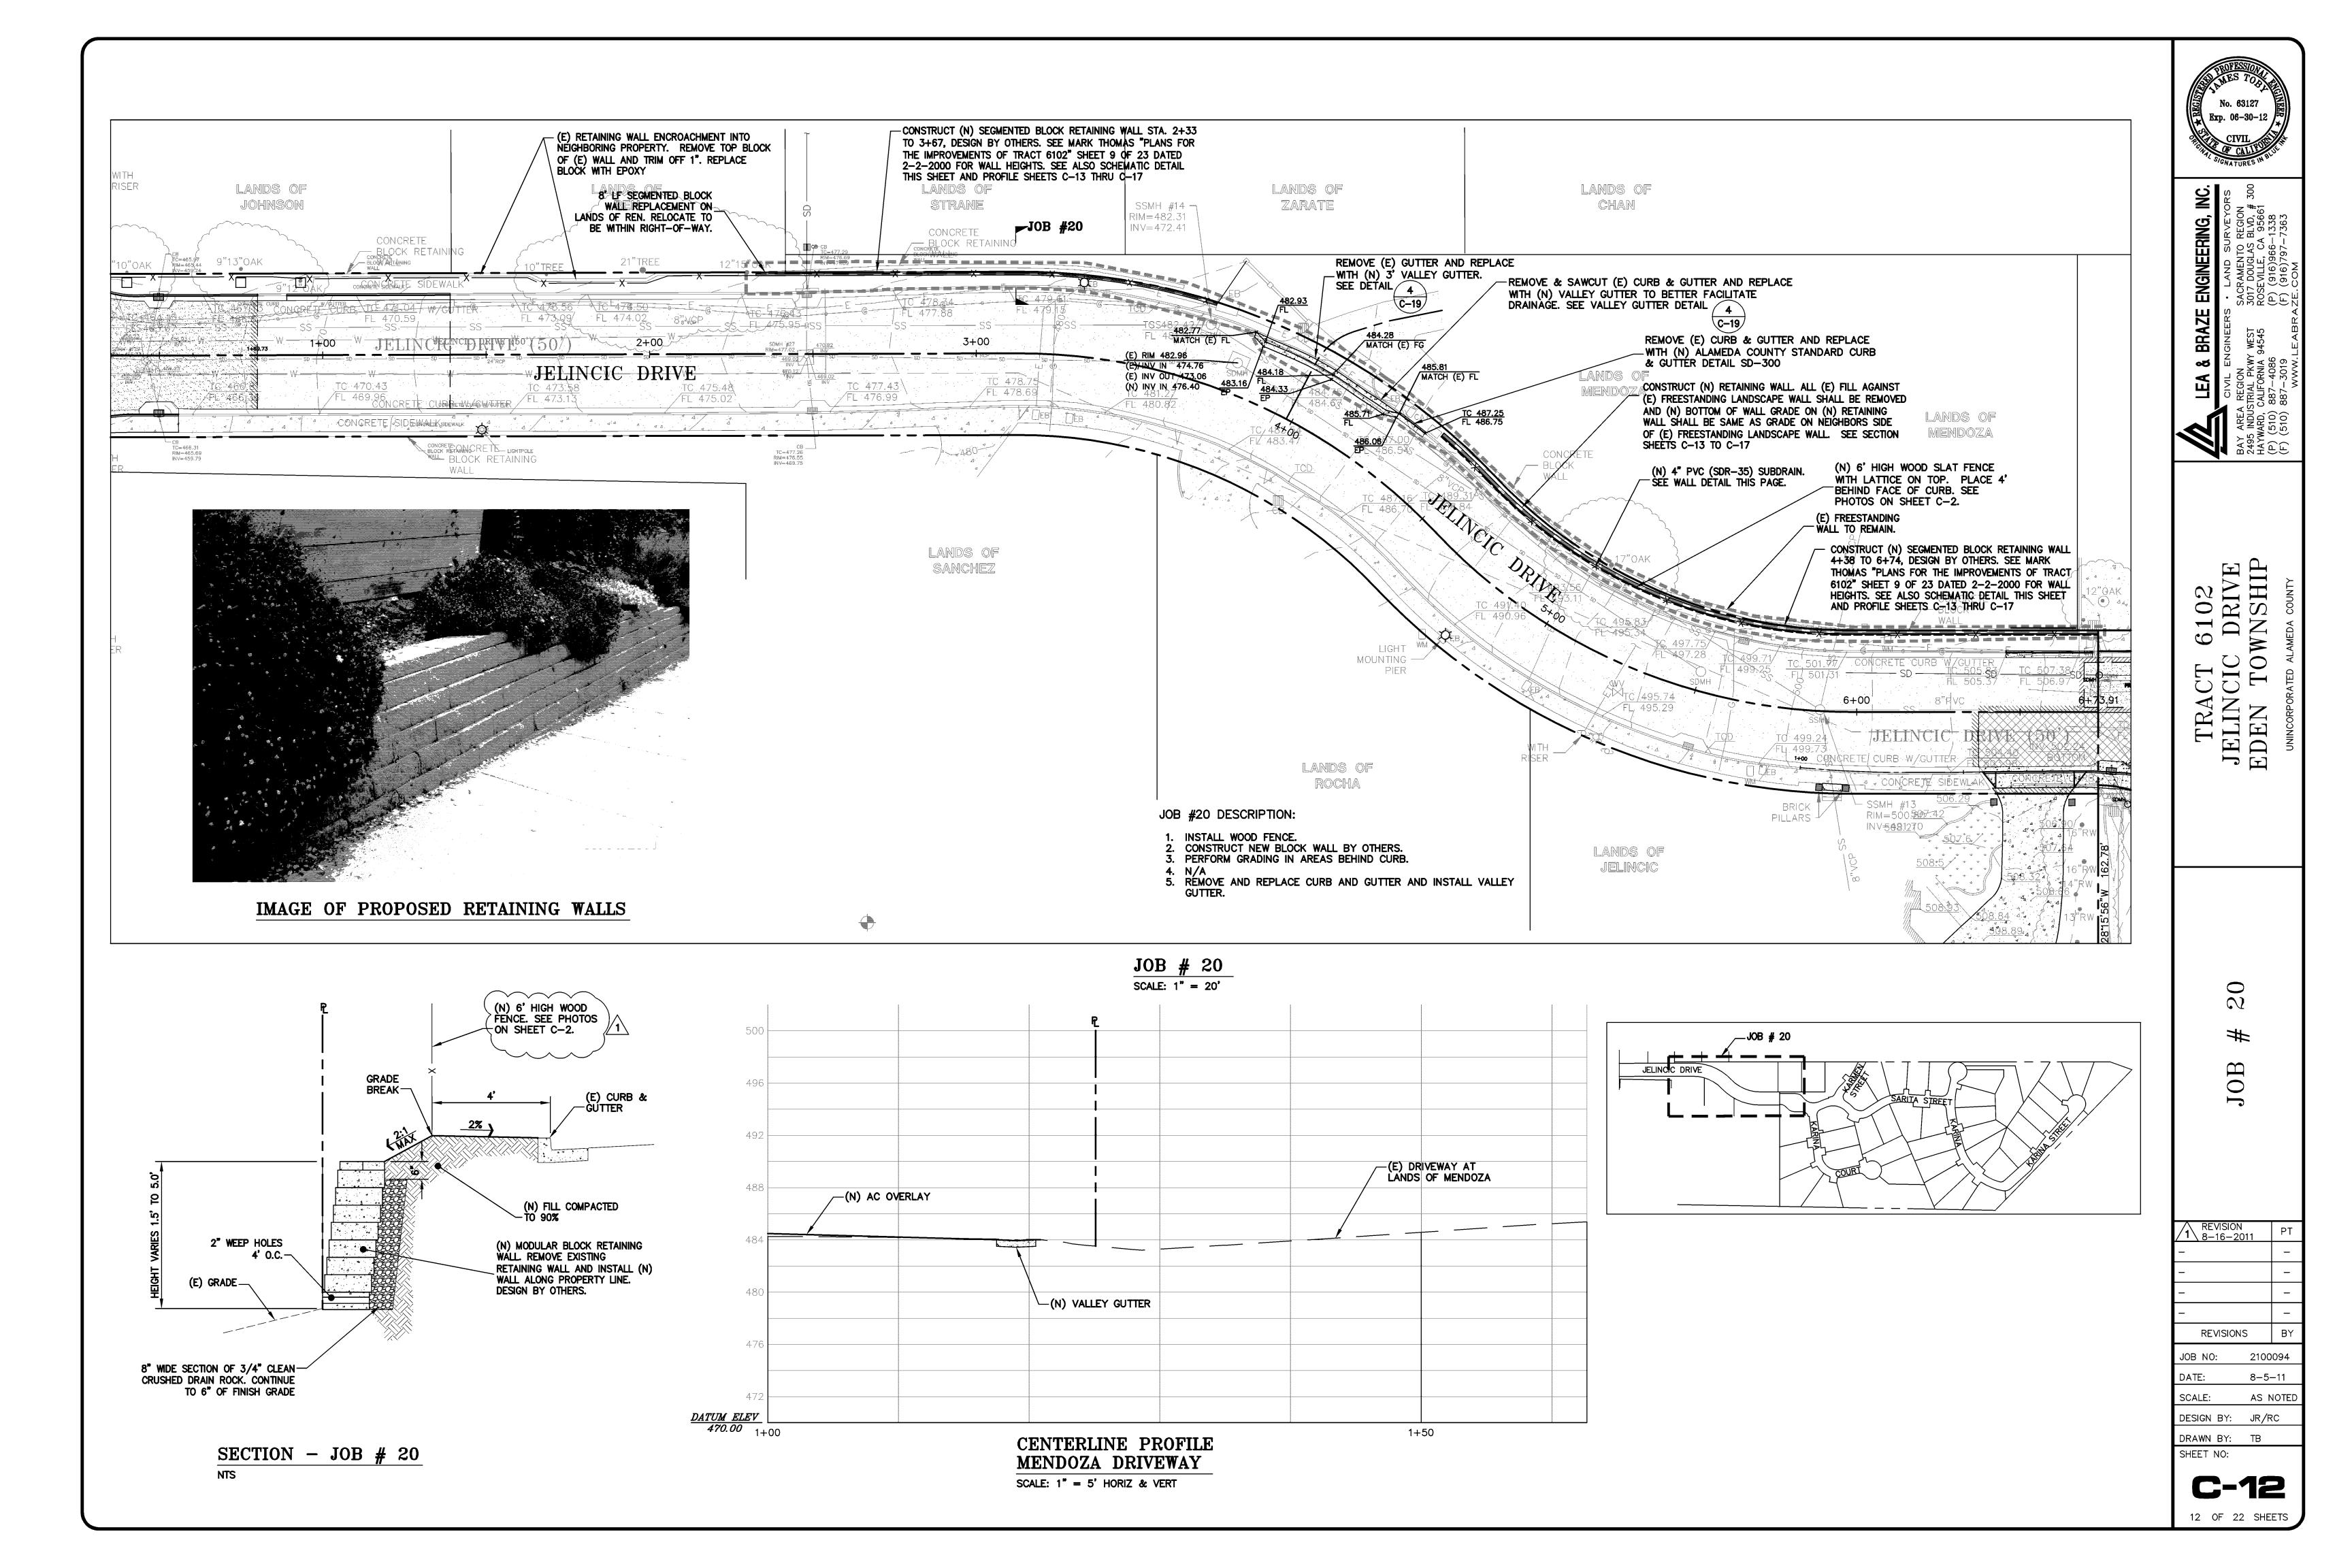
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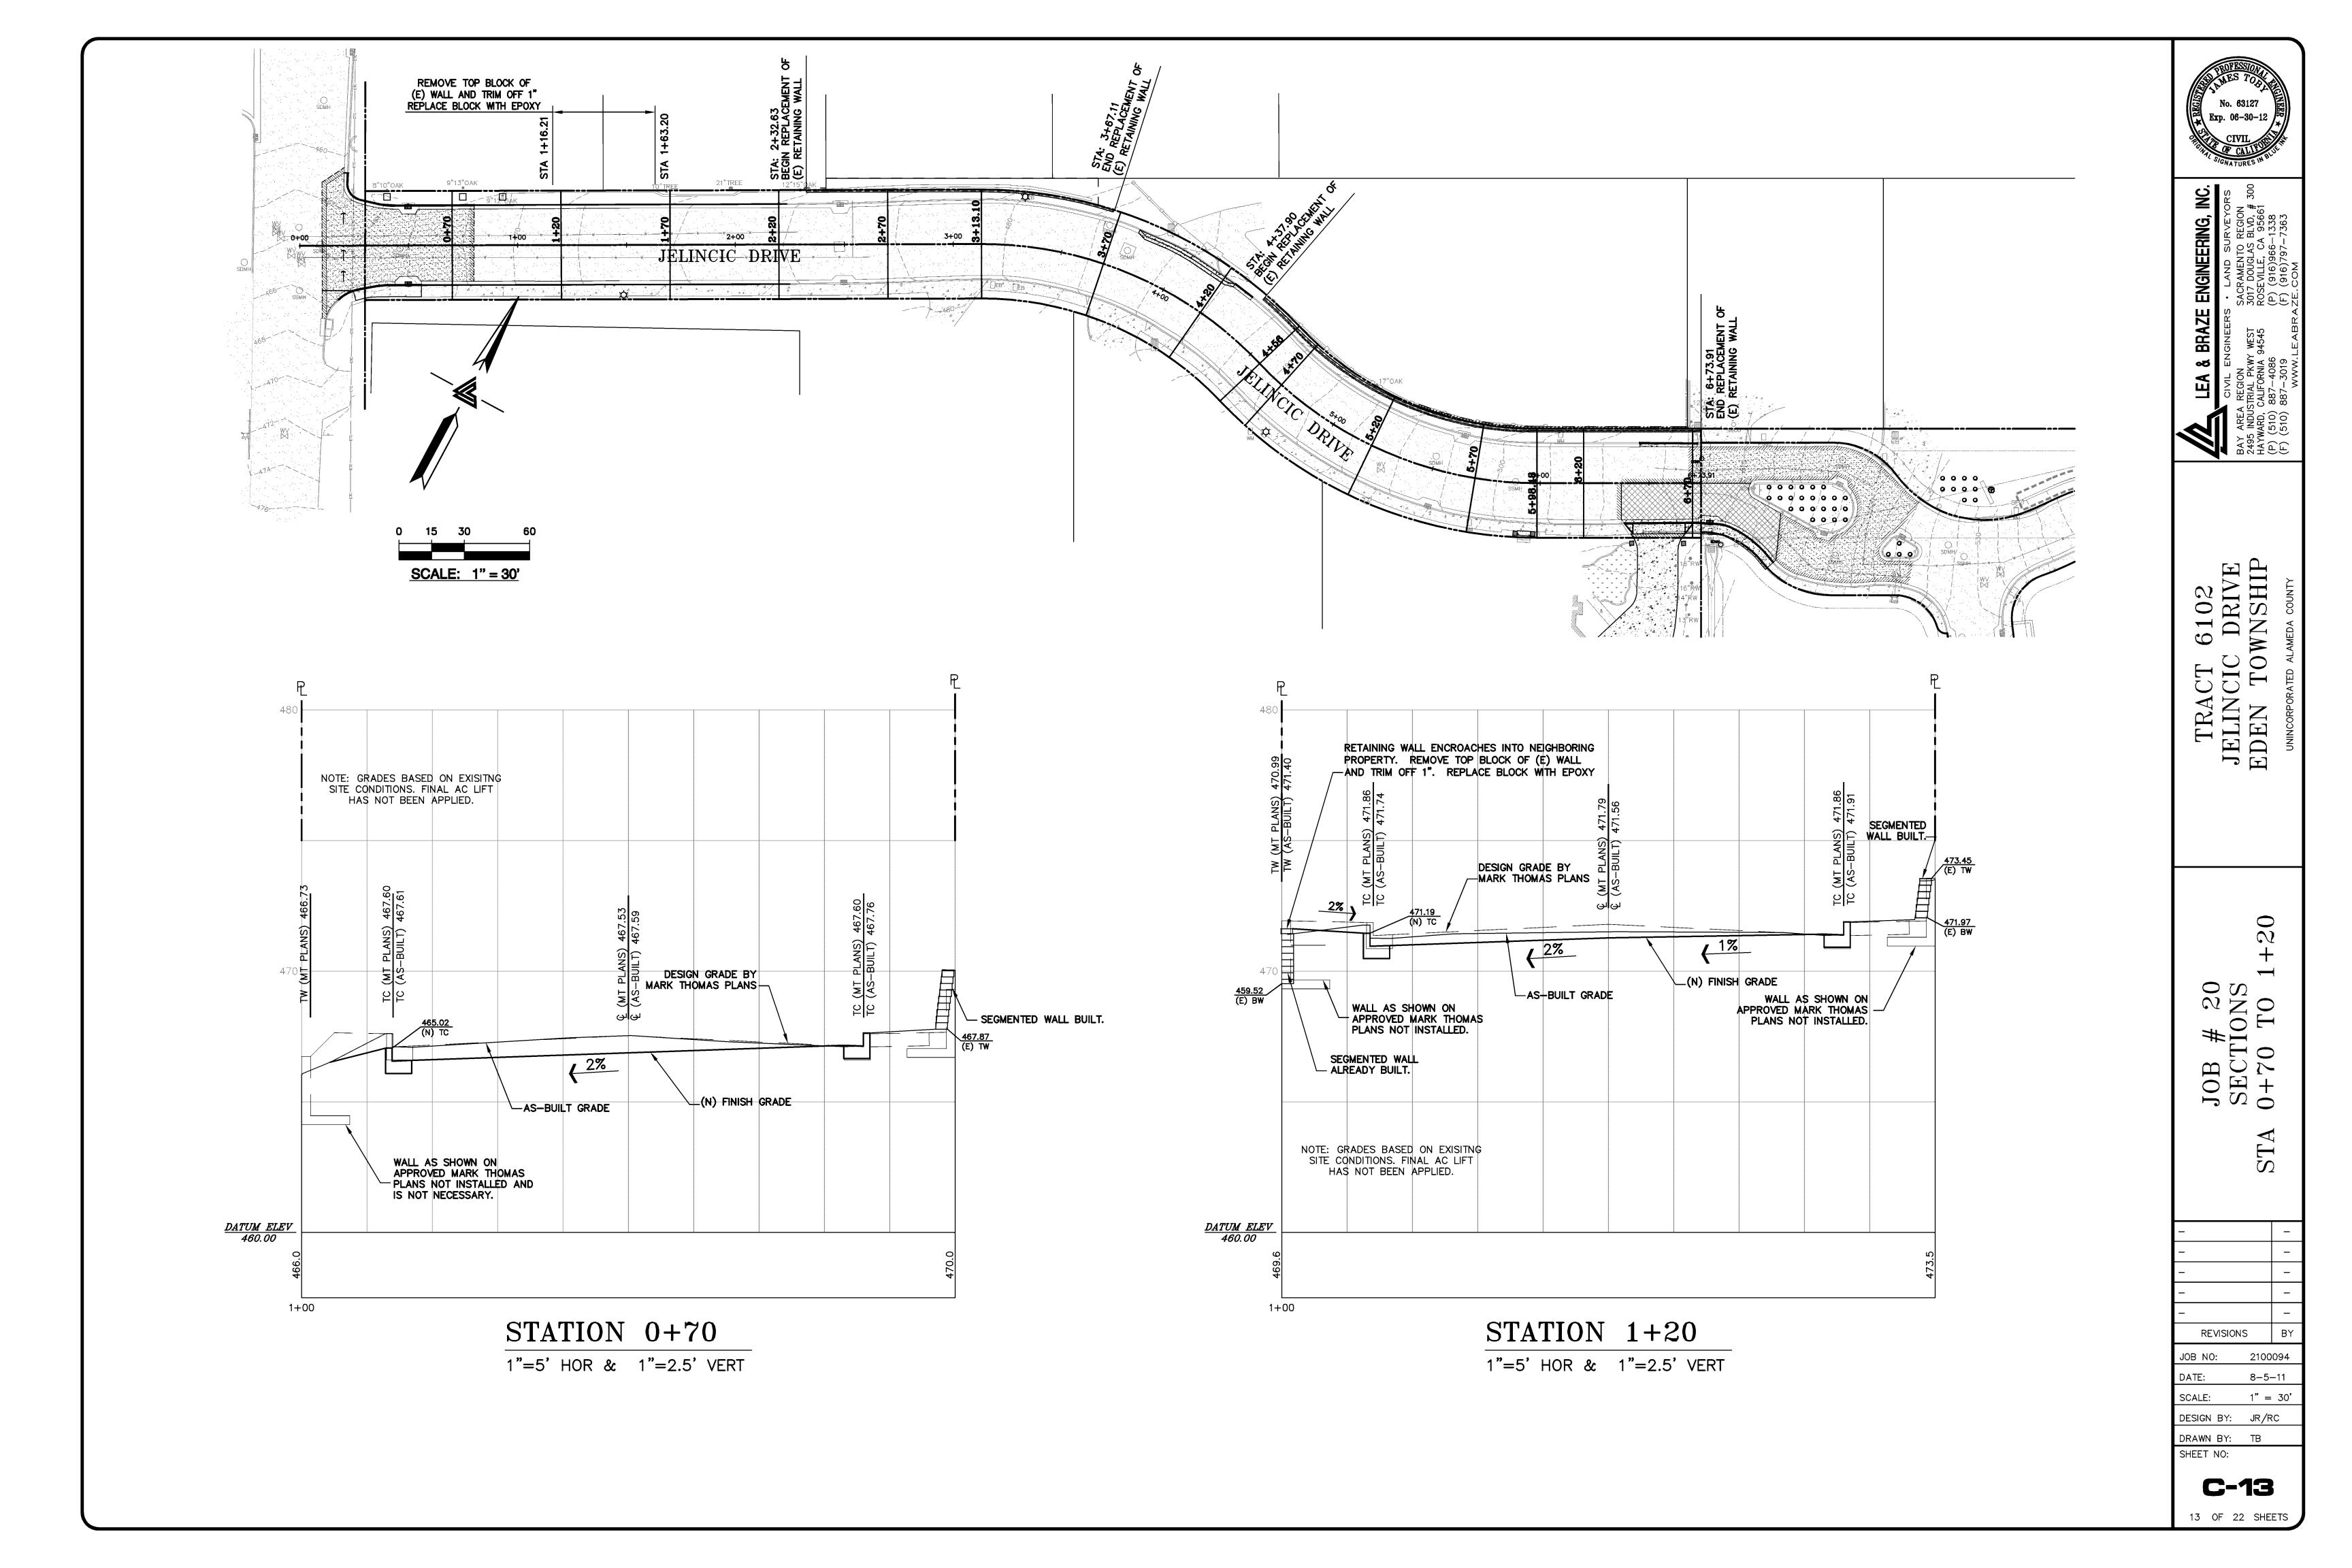
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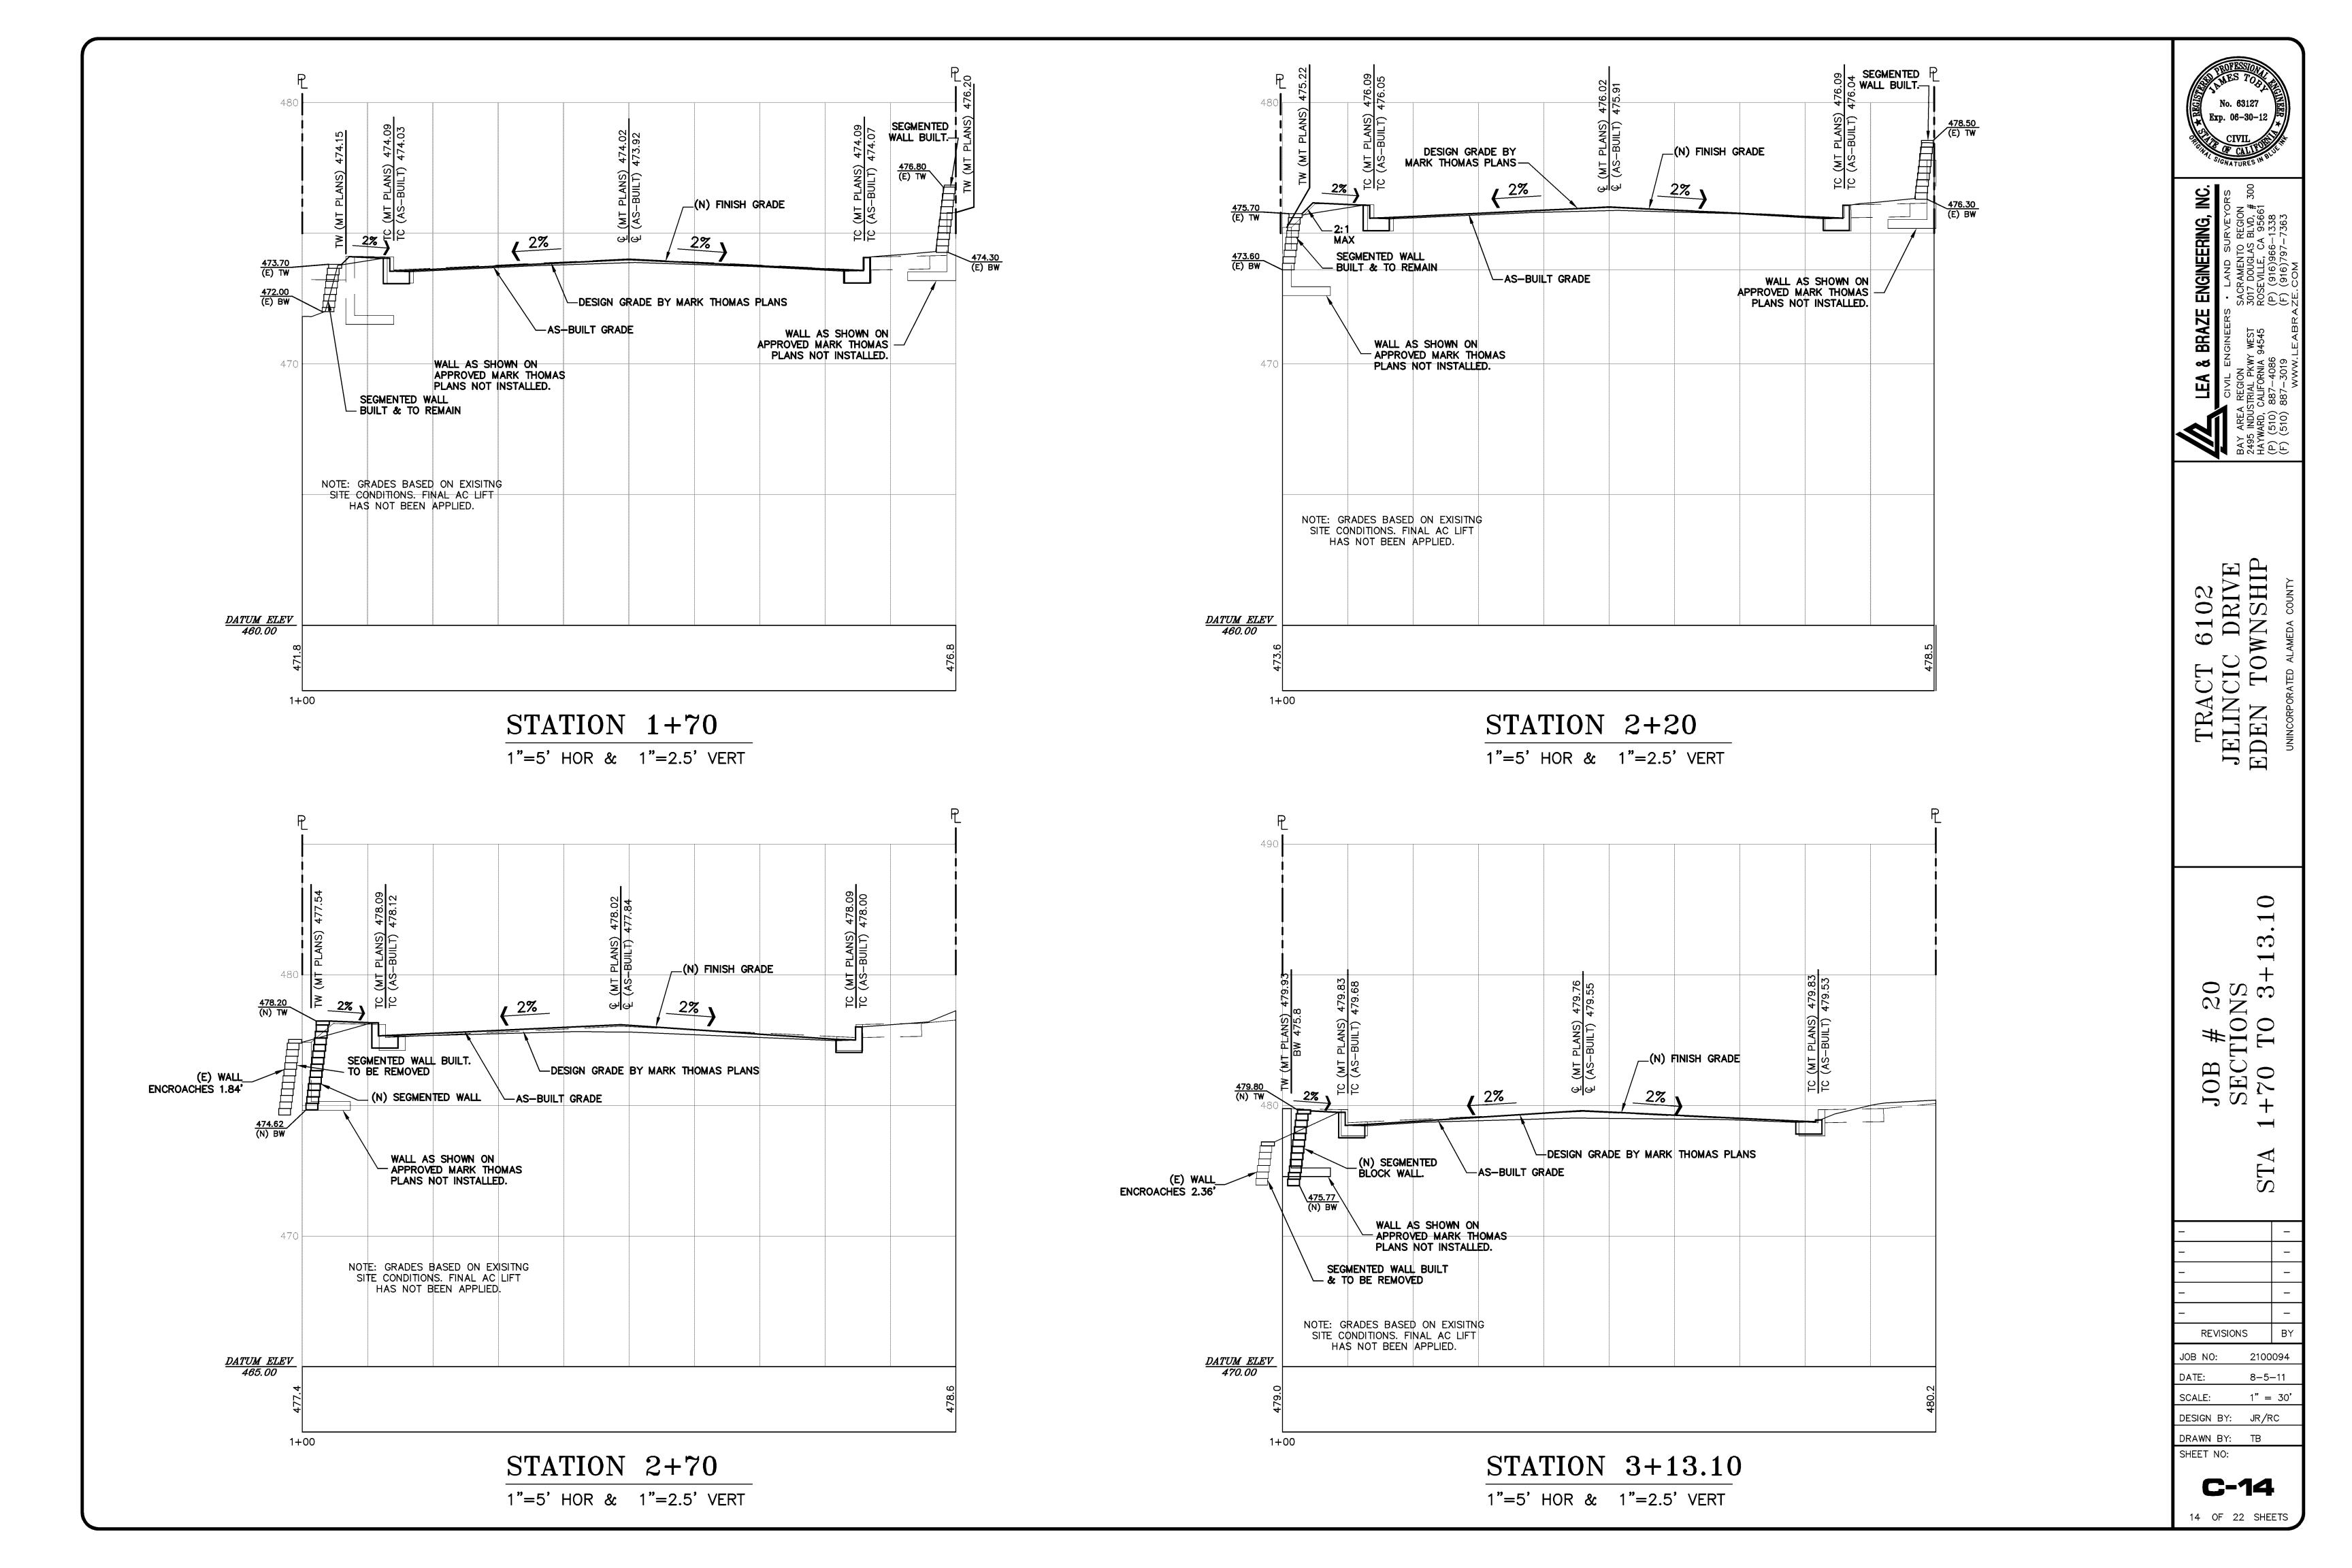
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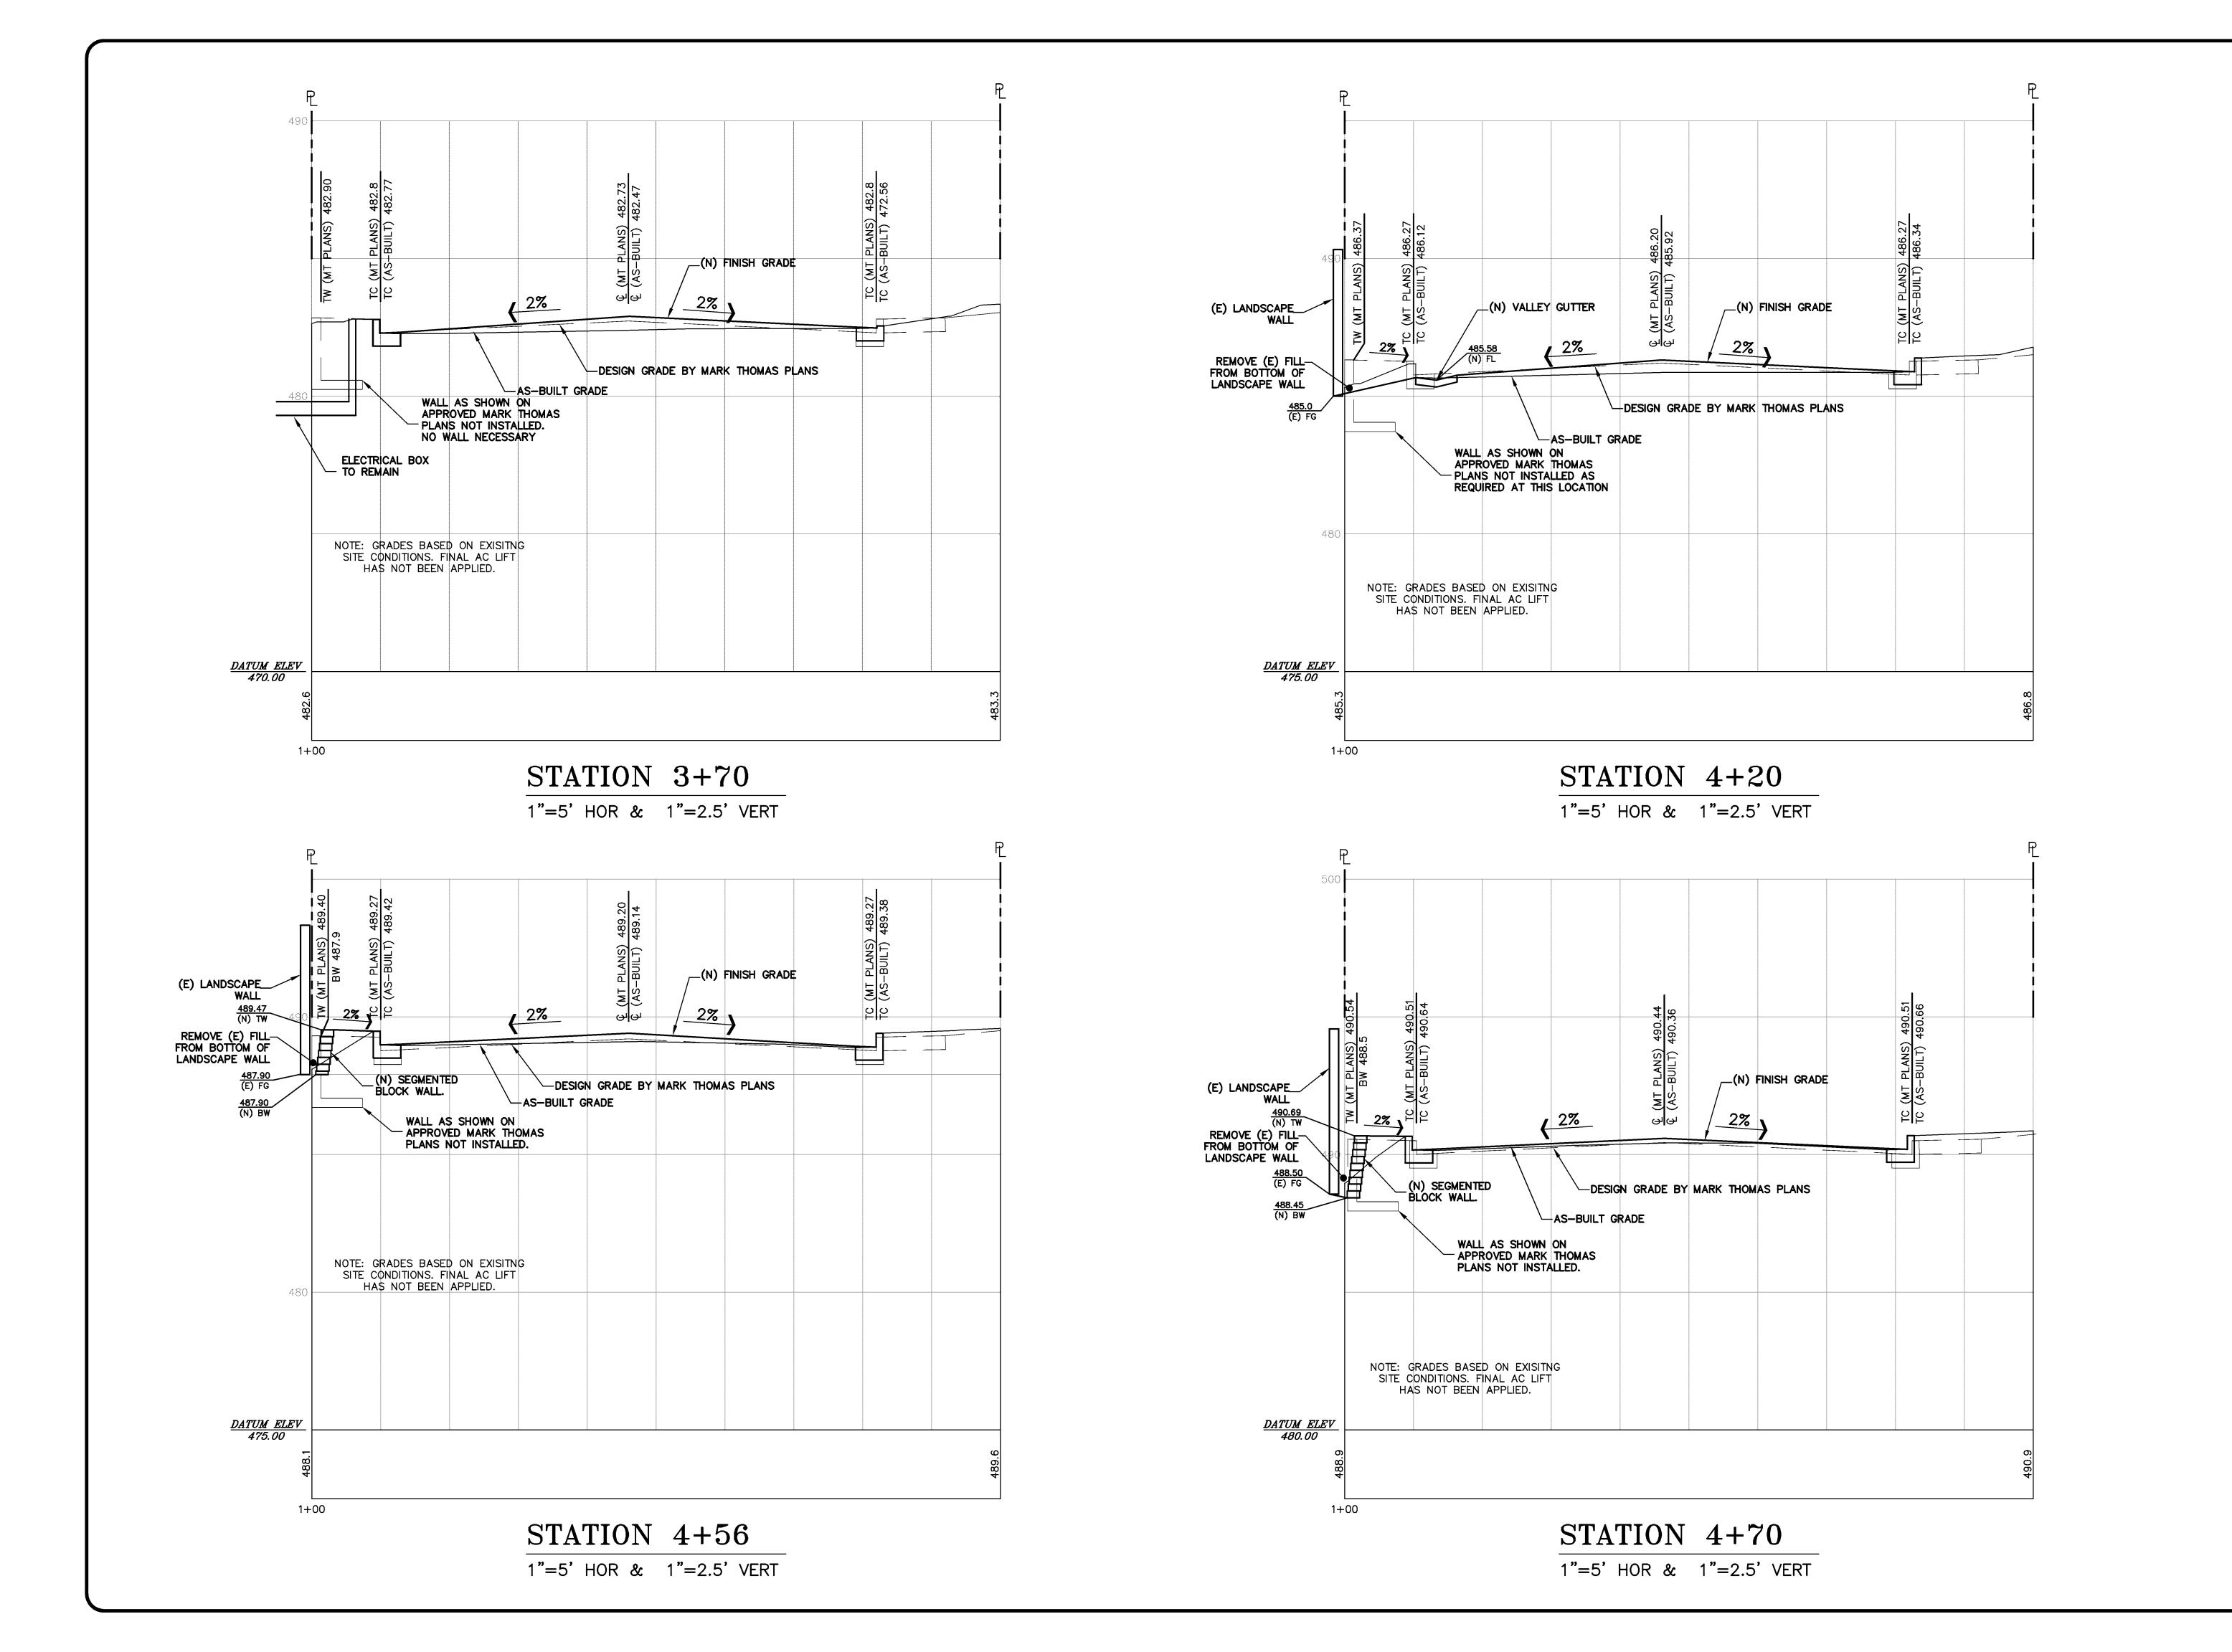
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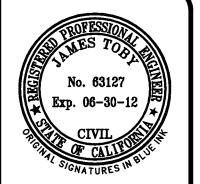












CIVIL ENGINEERS · LAND S

Y AREA REGION
SACRAMENTC

95 INDUSTRIAL PKWY WEST
YWARD, CALIFORNIA 94545
(7) (916)966

TRACT 6102 JELINCIC DRIVE EDEN TOWNSHIF

JOB # 20 SECTIONS [A 3+70 TO 4+70

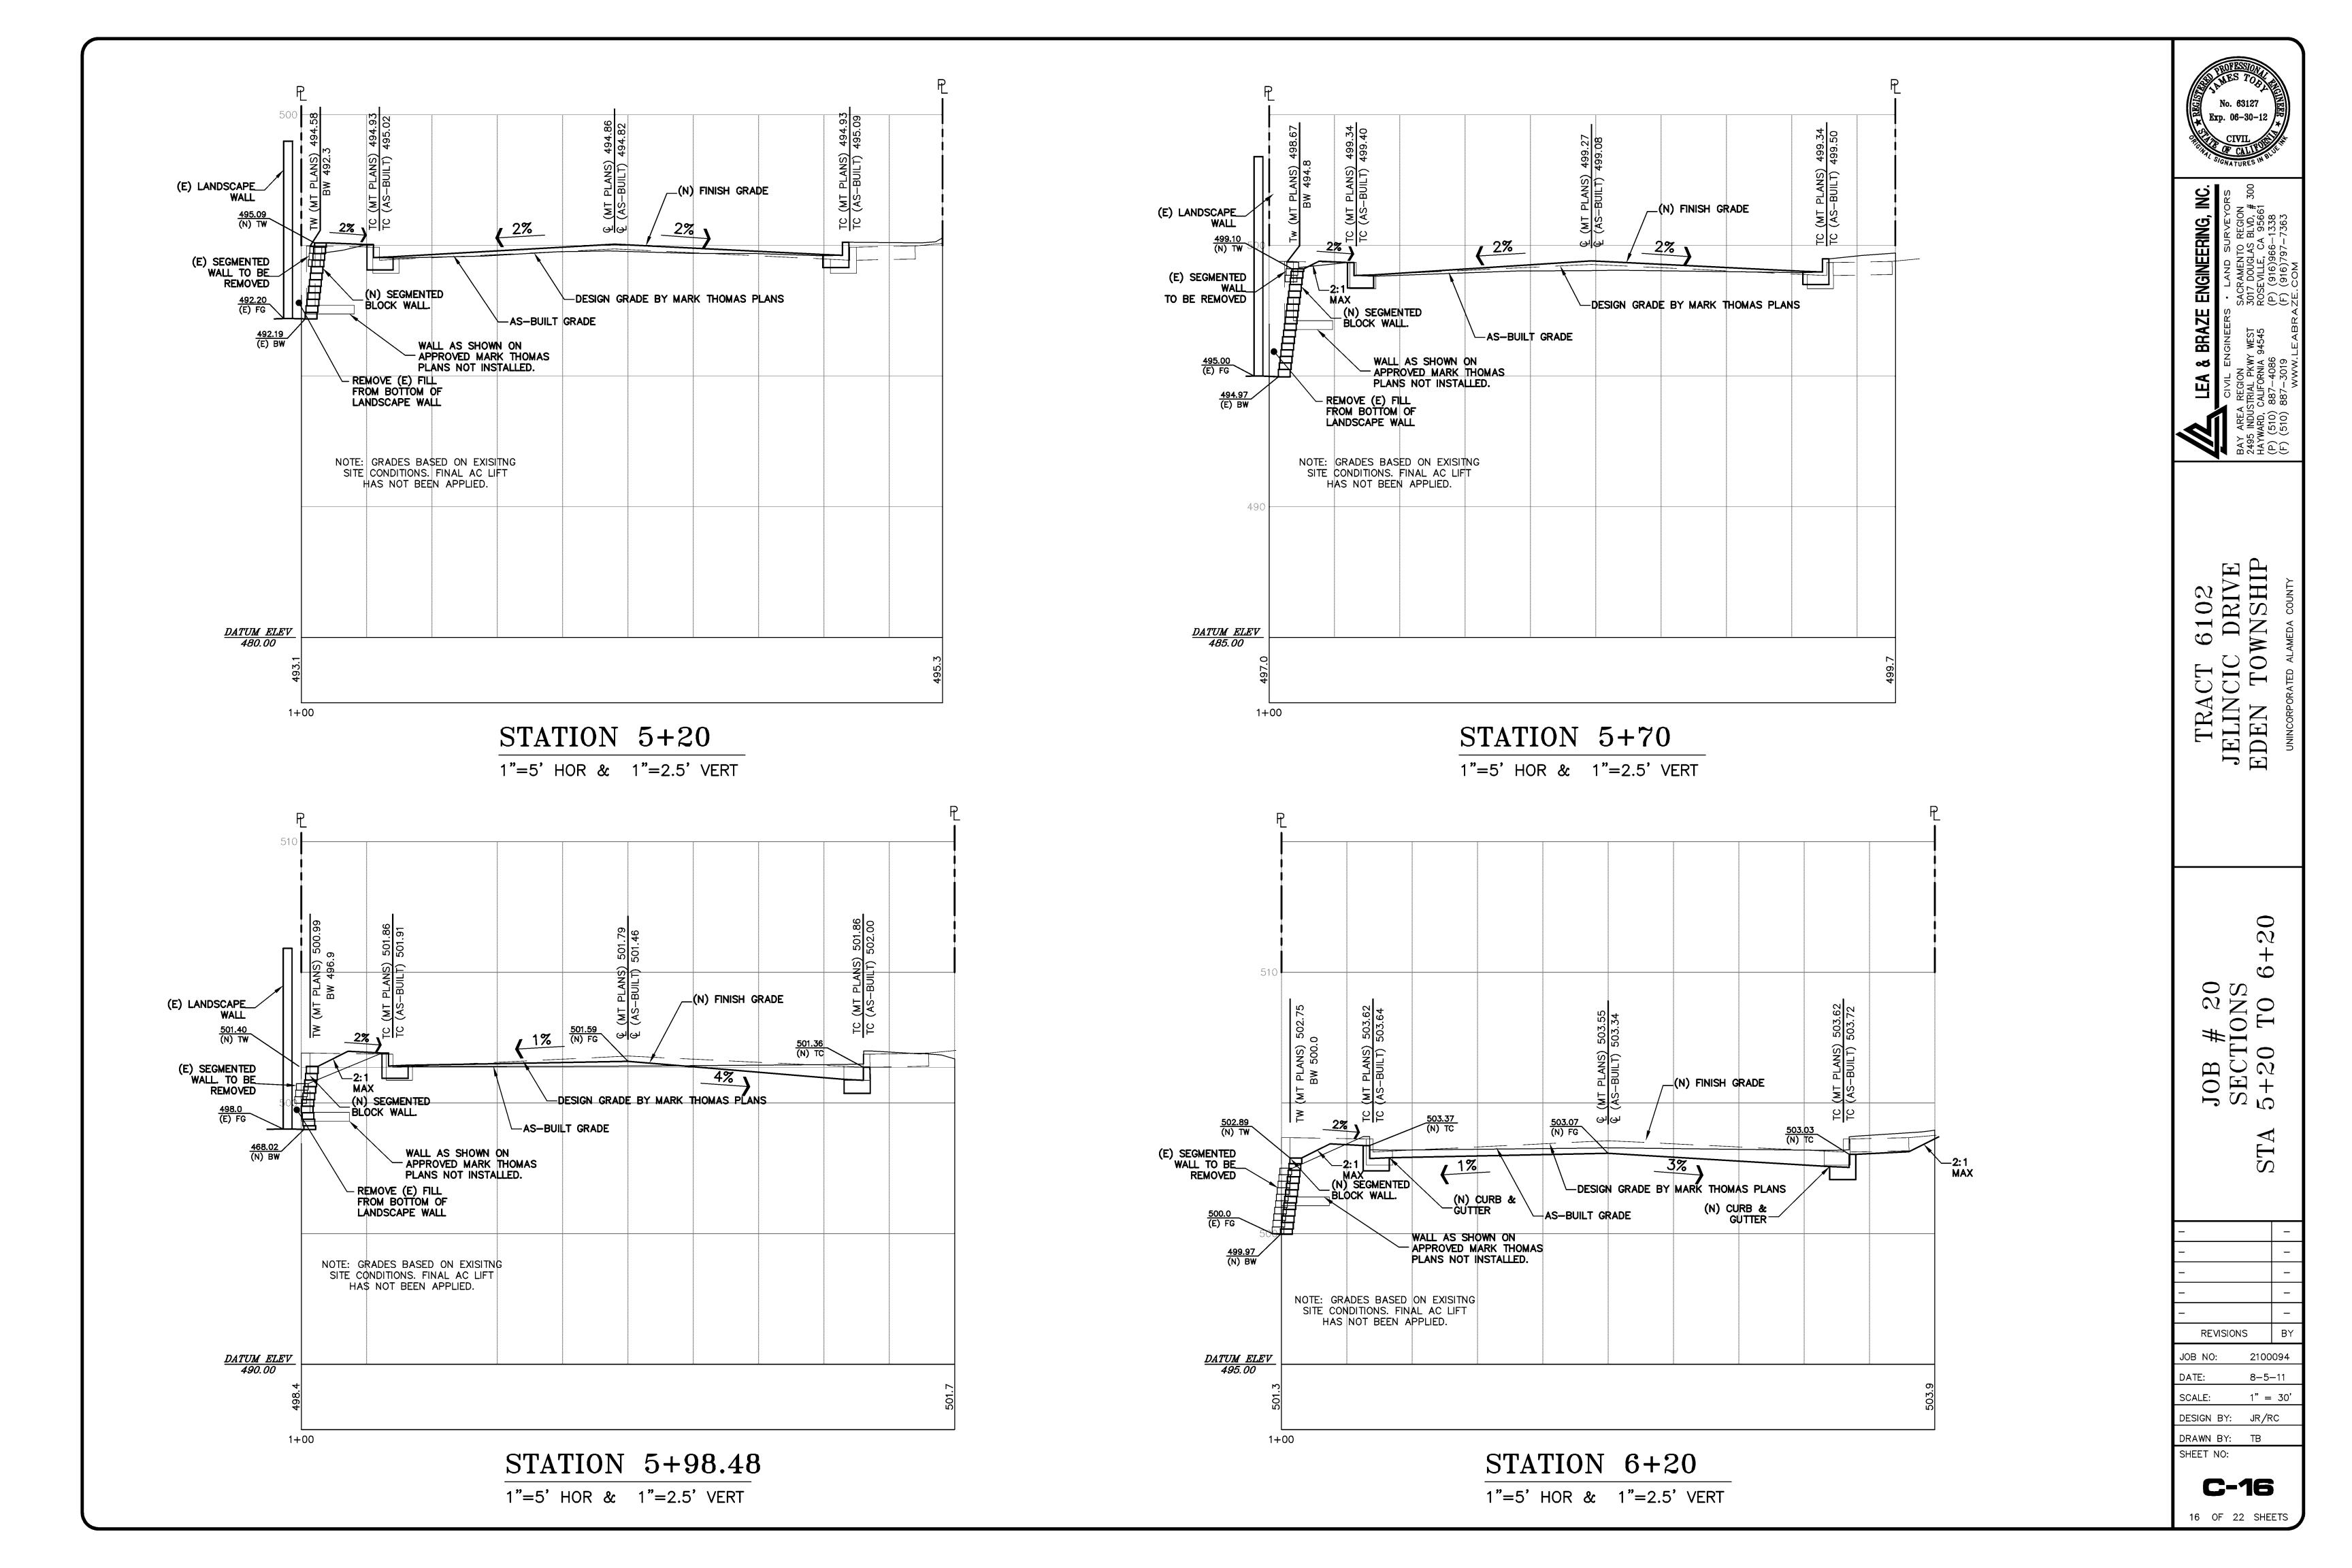
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1"=5' HOR & 1"=2.5' VERT

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SACRAMENTO REGION
3017 DOUGLAS BLVD, # 300
ROSEVILLE, CA 95661

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TRACT 6102 JELINCIC DRIVE EDEN TOWNSHIP

JOB # 20 SECTIONS STA 6+70

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DATE: 8-5-11

SCALE: 1" = 30'

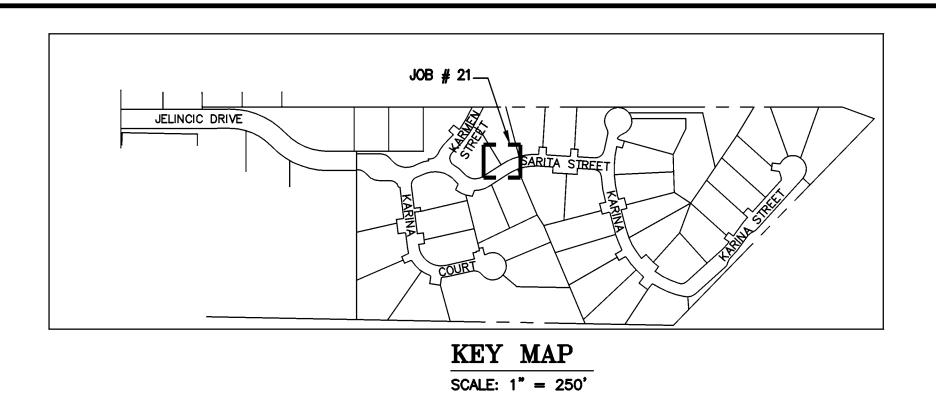
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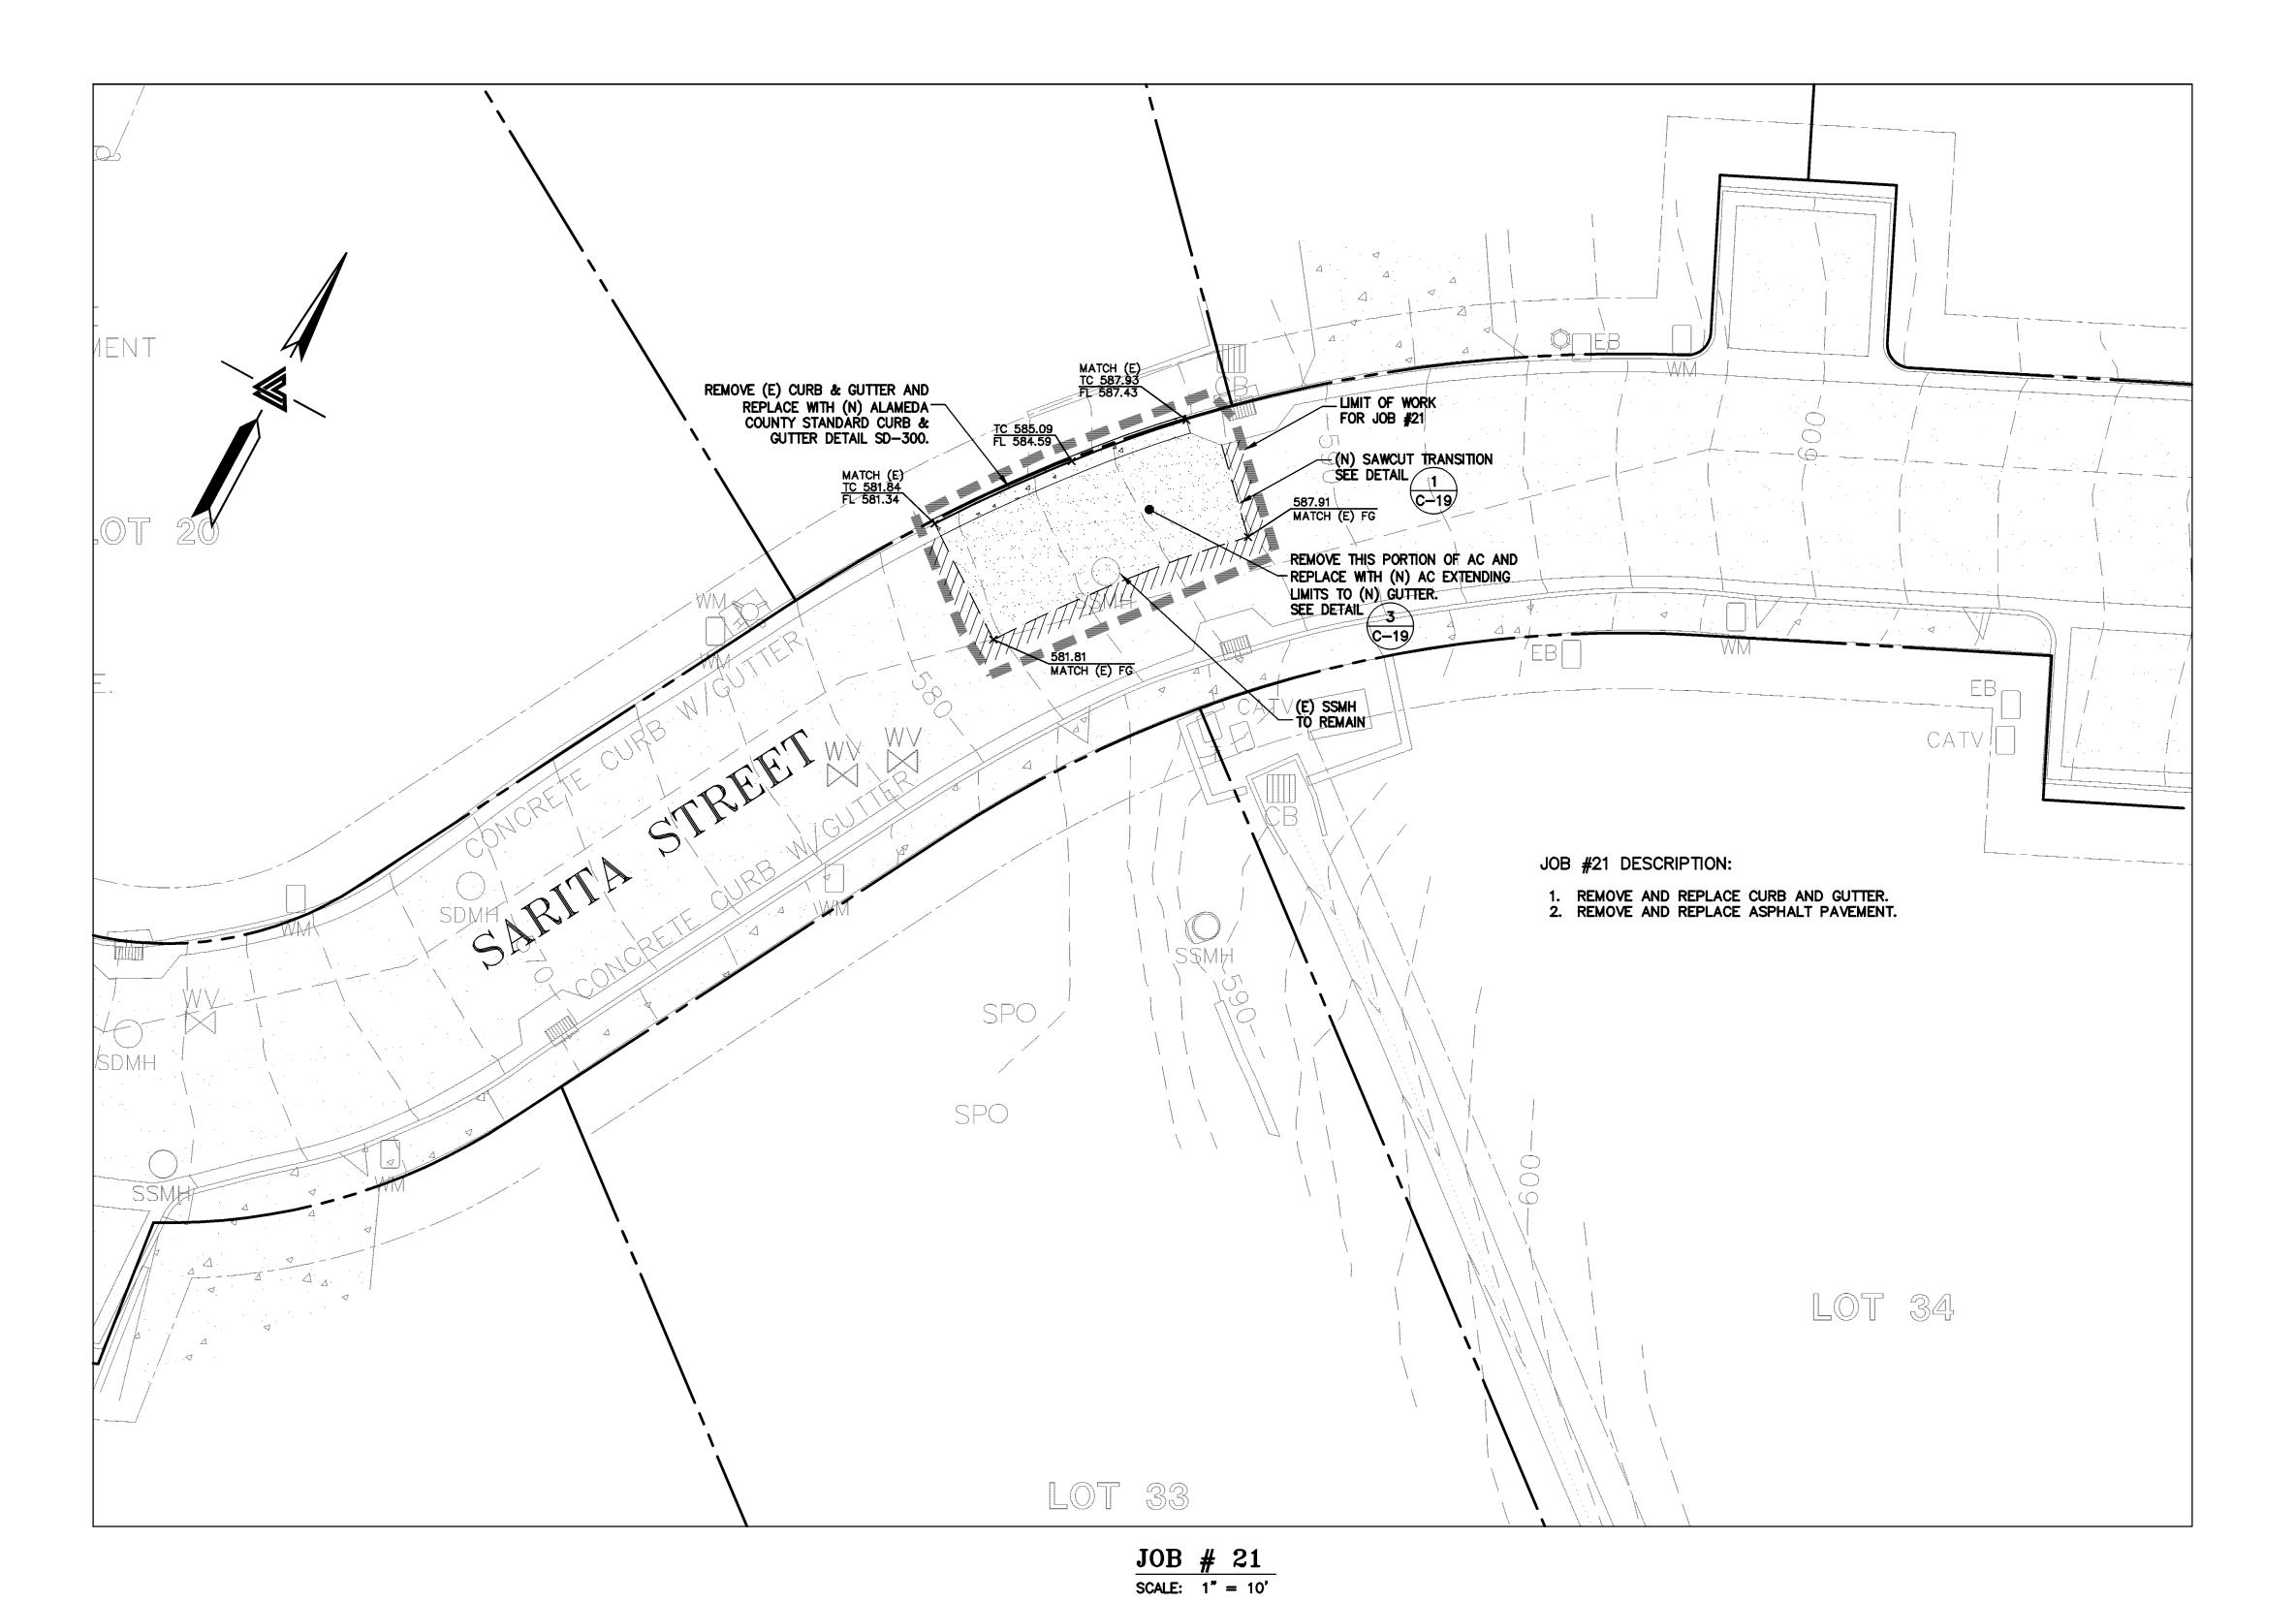
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Exp. 06-30-12

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(916)797-7363

ENGINEERS · LAND SURVEY
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86 (P) (916)966-1338

CIVIL ENGINEERS •

BAY AREA REGION
2495 INDUSTRIAL PKWY WEST 3017
HAYWARD, CALIFORNIA 94545 ROS
(P) (510) 887-4086 (P)
(F) (510) 887-3019 (F)

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JOB # 21

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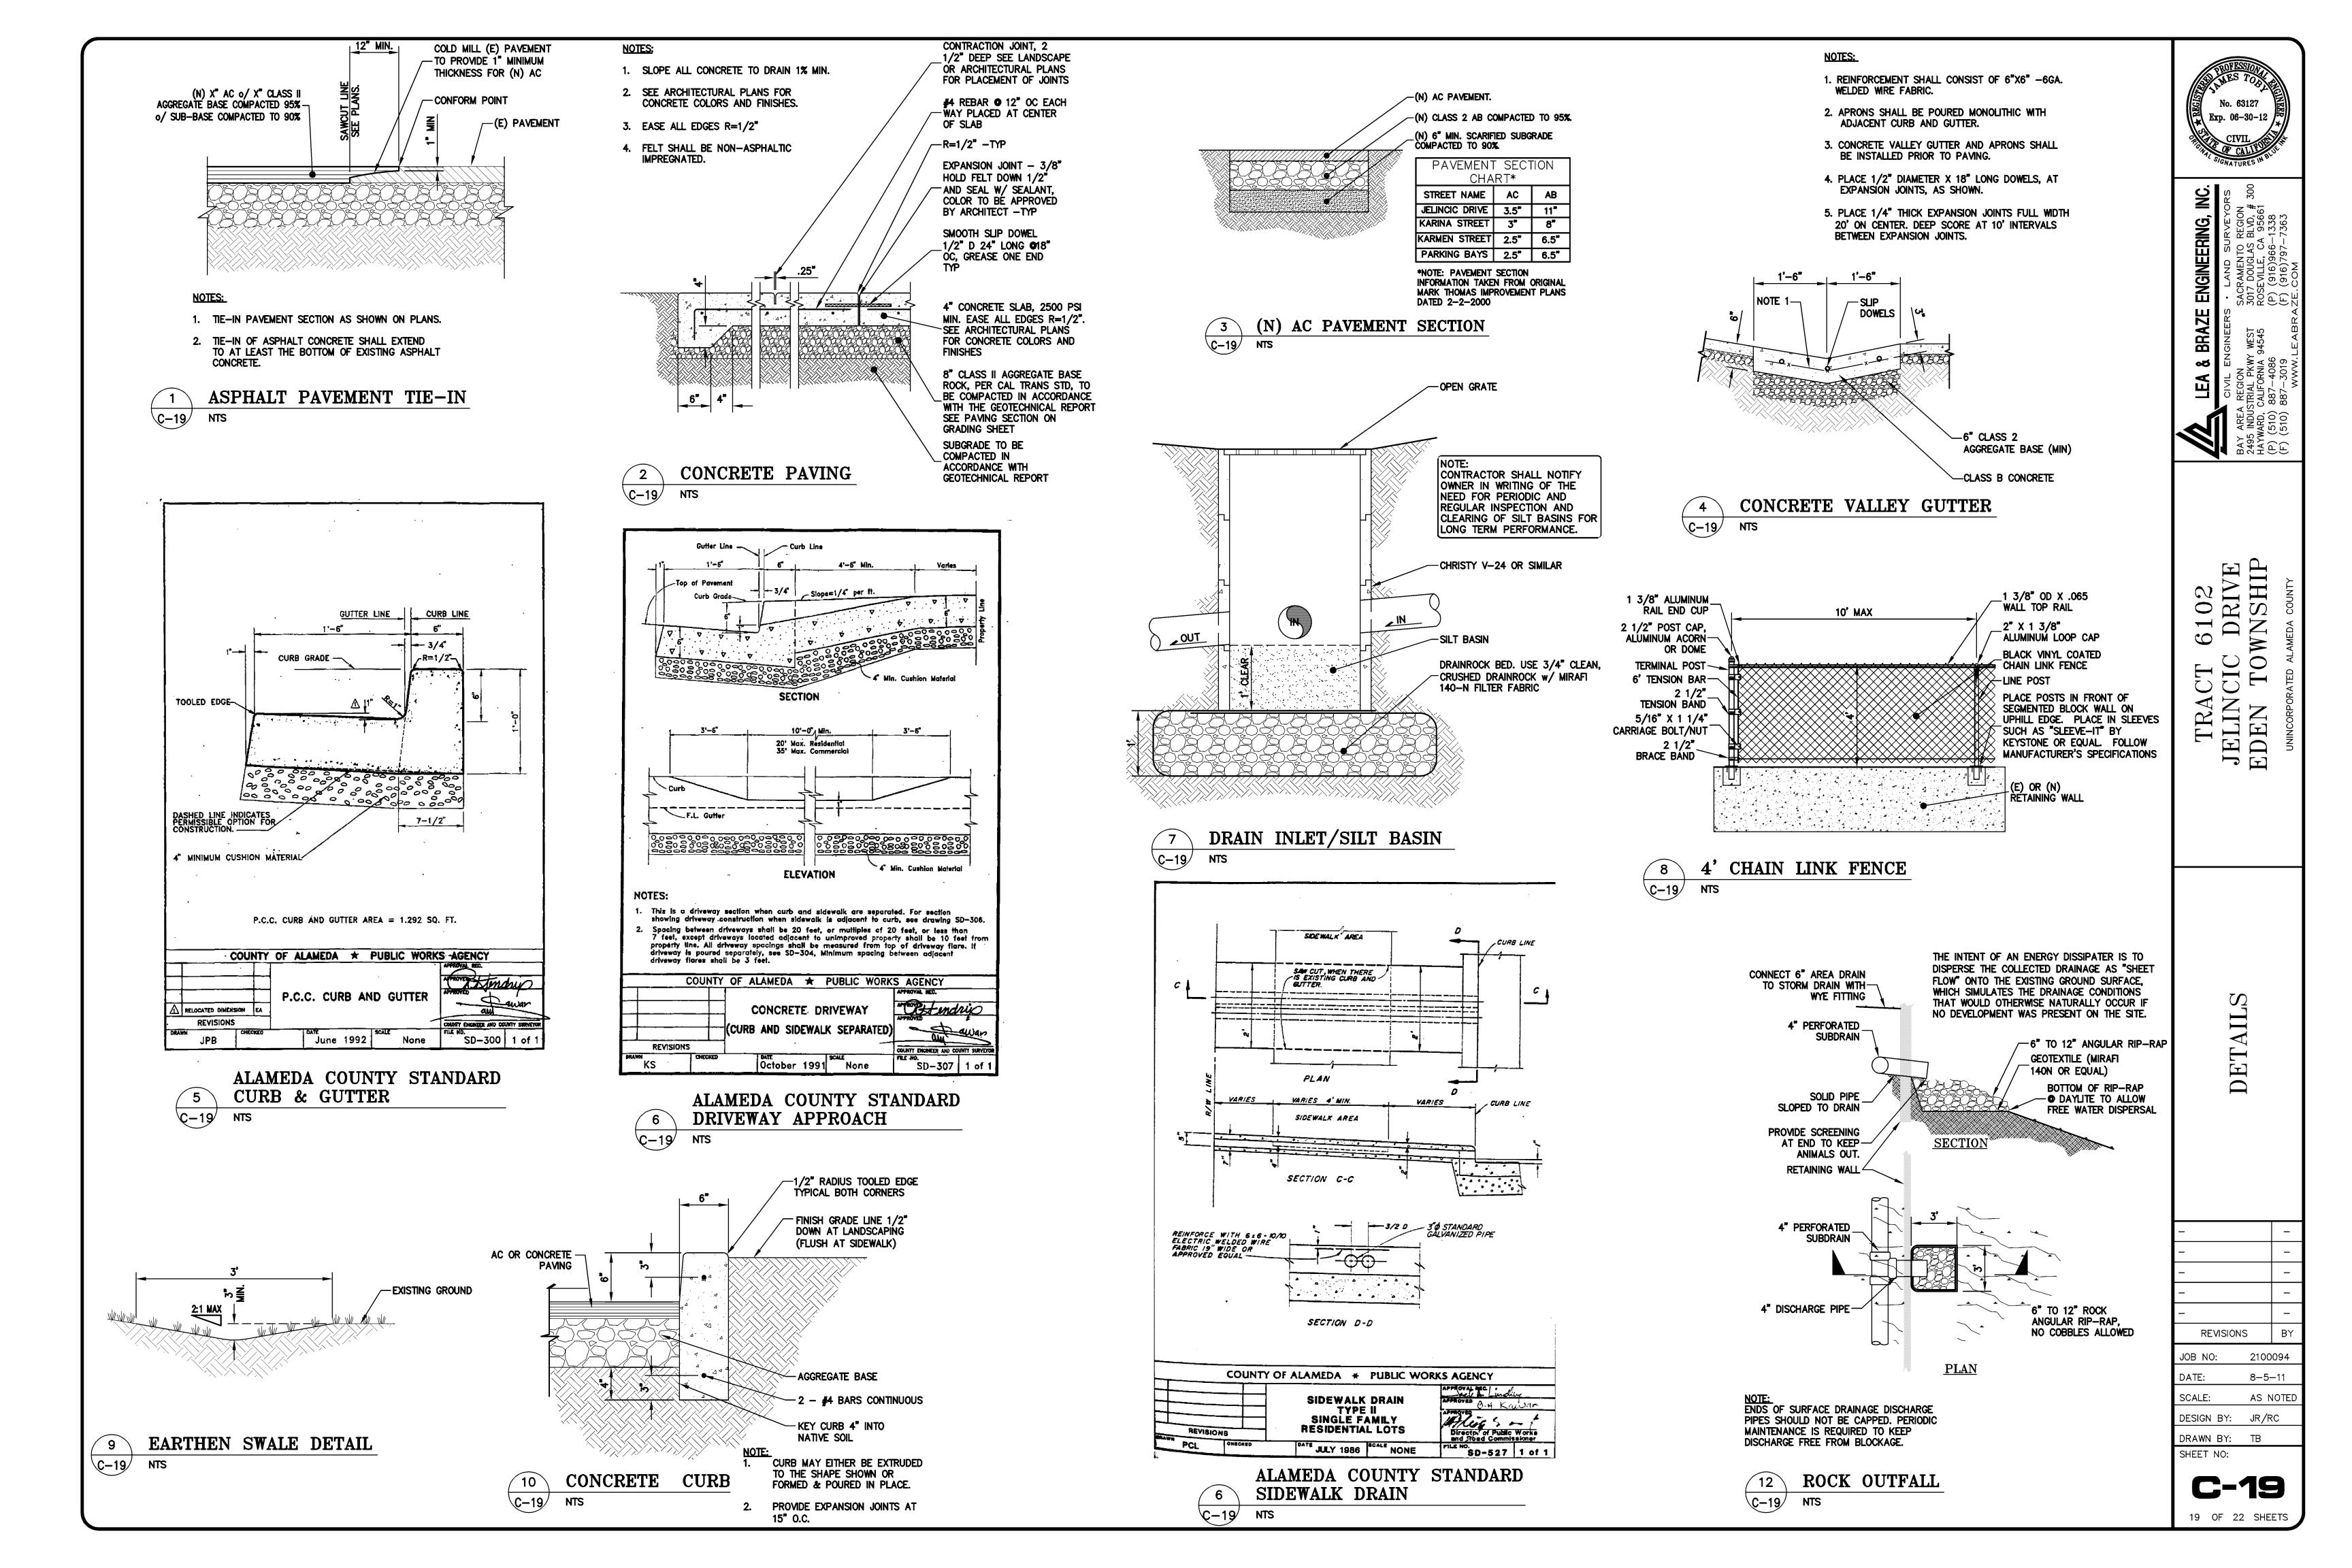
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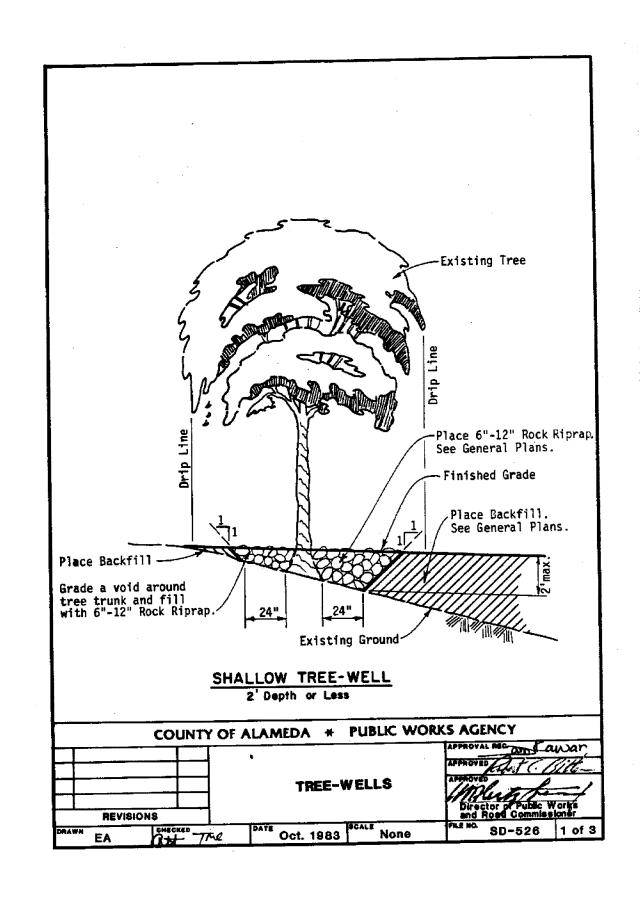
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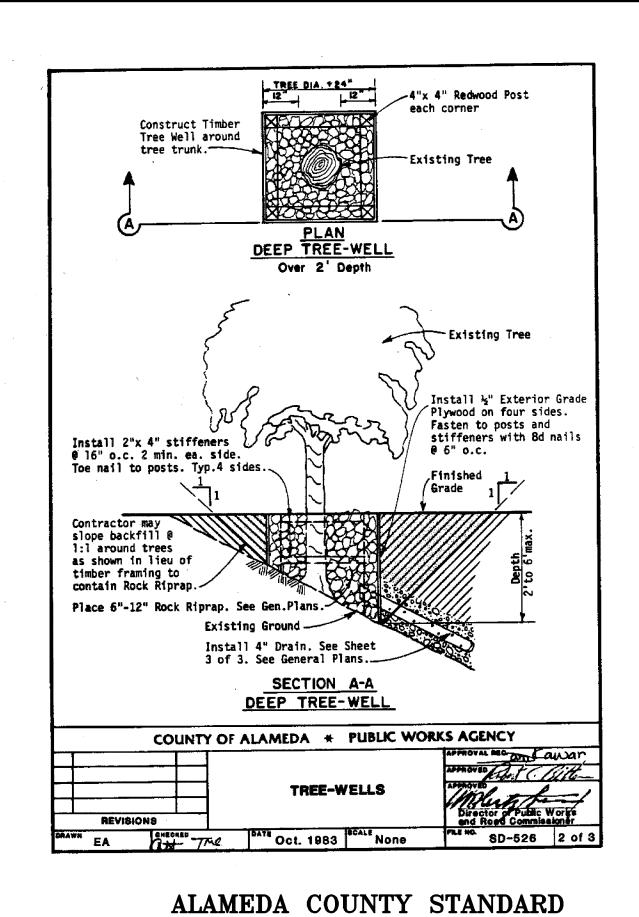
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18 OF 22 SHEETS

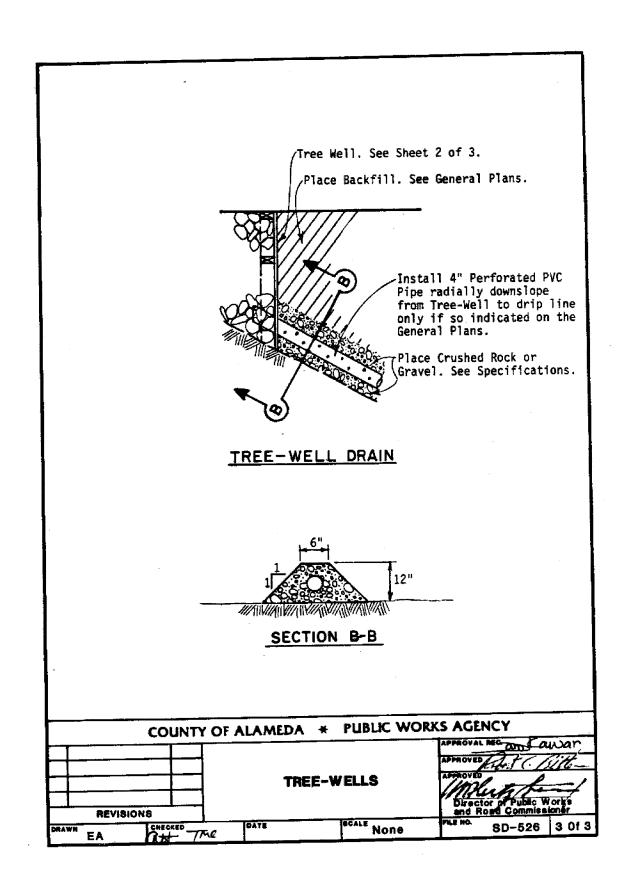


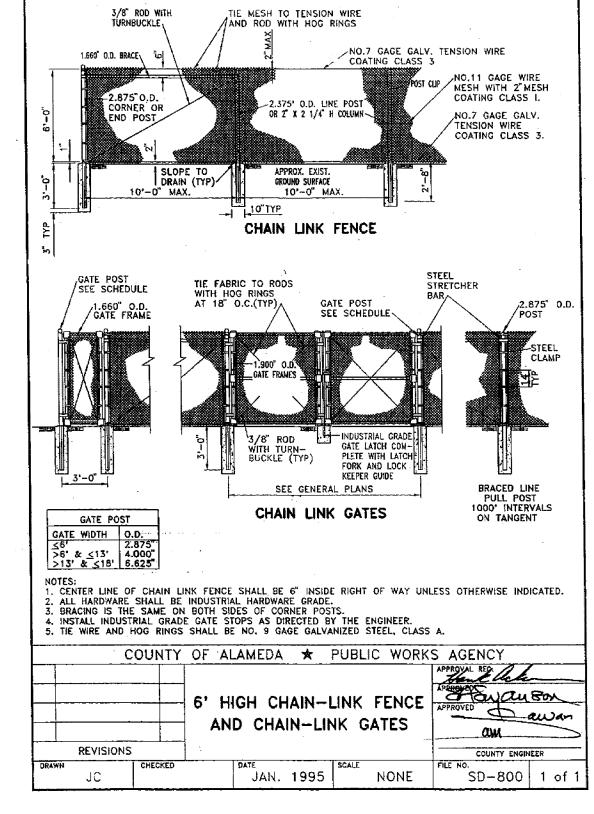




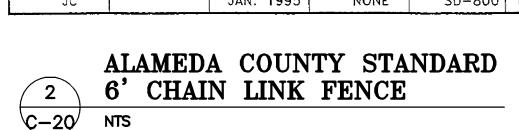
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DESIGN BY:	JR/RC	

EROSION CONTROL NOTES:

AND APPROVED EROSION CONTROL PLAN.

- 1. IT SHALL BE THE OWNER'S/CONTRACTOR'S RESPONSIBILITY TO MAINTAIN CONTROL OF THE ENTIRE CONSTRUCTION OPERATION AND TO KEEP THE ENTIRE SITE IN COMPLIANCE WITH THIS EROSION CONTROL PLAN.
- 2. THE INTENTION OF THIS PLAN IS FOR INTERIM EROSION AND SEDIMENT CONTROL ONLY. ALL EROSION CONTROL MEASURES SHALL CONFORM TO CALIFORNIA REGIONAL WATER QUALITY CONTROL BOARD'S FIELD MANUAL FOR EROSION AND SEDIMENTATION CONTROL, THE CALIFORNIA STORM WATER QUALITY ASSOCIATION BEST MANAGEMENT PRACTICES HANDBOOK FOR CONSTRUCTION, AND THE LOCAL GOVERNING AGENCY FOR THIS PROJECT.
- 3. OWNER/CONTRACTOR SHALL BE RESPONSIBLE FOR MONITORING EROSION AND SEDIMENT CONTROL MEASURES PRIOR TO, DURING, AND AFTER STORM EVENTS. PERSON IN CHARGE OF MAINTAINING EROSION CONTROL MEASURES SHOULD WATCH LOCAL WEATHER REPORTS AND ACT APPROPRIATELY TO MAKE SURE ALL NECESSARY MEASURES ARE IN PLACE.
- 4. SANITARY FACILITIES SHALL BE MAINTAINED ON THE SITE AT ALL TIMES.
- 5. DURING THE RAINY SEASON, ALL PAVED AREAS SHALL BE KEPT CLEAR OF EARTH MATERIAL AND DEBRIS. THE SITE SHALL BE MAINTAINED SO AS TO MINIMIZE SEDIMENT—LADEN RUNOFF TO ANY STORM DRAINAGE SYSTEM, INCLUDING EXISTING DRAINAGE SWALES AND WATERCOURSES.
- 6. CONSTRUCTION OPERATIONS SHALL BE CARRIED OUT IN SUCH A MANNER THAT EROSION AND WATER POLLUTION WILL BE MINIMIZED. COMPLIANCE WITH FEDERAL, STATE AND LOCAL LAWS CONCERNING POLLUTION SHALL BE MAINTAINED AT ALL TIMES.
- 7. CONTRACTOR SHALL PROVIDE DUST CONTROL AS REQUIRED BY THE APPROPRIATE FEDERAL, STATE AND LOCAL AGENCY REQUIREMENTS.
- 8. ALL MATERIALS NECESSARY FOR THE APPROVED EROSION CONTROL MEASURES SHALL BE IN PLACE BY OCTOBER 15TH.
- 9. EROSION CONTROL SYSTEMS SHALL BE INSTALLED AND MAINTAINED THROUGHOUT THE
- RAINY SEASON, OR FROM OCTOBER 15TH THROUGH APRIL 15TH, WHICHEVER IS LONGER.

 10. IN THE EVENT OF RAIN, ALL GRADING WORK IS TO CEASE IMMEDIATELY AND THE SITE

IS TO BE SEALED IN ACCORDANCE WITH THE APPROVAL EROSION CONTROL MEASURES

- 11. THE CONTRACTOR SHALL BE RESPONSIBLE FOR CHECKING AND REPAIRING EROSION CONTROL SYSTEMS AFTER EACH STORM.
- 12. ADDITIONAL EROSION CONTROL MEASURES MAY BE REQUIRED BY LOCAL JURISDICTION'S ENGINEERING DEPARTMENT OR BUILDING OFFICIALS.
- 13. MEASURES SHALL BE TAKEN TO COLLECT OR CLEAN ANY ACCUMULATION OR DEPOSIT OF DIRT, MUD, SAND, ROCKS, GRAVEL OR DEBRIS ON THE SURFACE OF ANY STREET, ALLEY OR PUBLIC PLACE OR IN ANY PUBLIC STORM DRAIN SYSTEMS. THE REMOVAL OF AFORESAID SHALL BE DONE BY STREET SWEEPING OR HAND SWEEPING. WATER SHALL NOT BE USED TO WASH SEDIMENTS INTO PUBLIC OR PRIVATE DRAINAGE FACILITIES.
- 14. EROSION CONTROL MEASURES SHALL BE ON-SITE FROM SEPTEMBER 15TH THRU APRIL
- 15. ALL EROSION CONTROL MEASURES SHALL BE INSTALLED AND MAINTAINED THROUGHOUT THE RAINY SEASON OR FROM OCTOBER 15 THRU APRIL 15, WHICHEVER IS GREATER.

EROSION CONTROL MEASURES:

- 1. THE FACILITIES SHOWN ON THIS PLAN ARE DESIGNED TO CONTROL EROSION AND SEDIMENT DURING THE RAINY SEASON, OCTOBER 15TH TO APRIL 15. EROSION CONTROL FACILITIES SHALL BE IN PLACE PRIOR TO OCTOBER 15TH OF ANY YEAR. GRADING OPERATIONS DURING THE RAINY SEASON WHICH LEAVE DENUDED SLOPES SHALL BE PROTECTED WITH EROSION CONTROL MEASURES IMMEDIATELY FOLLOWING GRADING ON THE SLOPES.
- 2. SITE CONDITIONS AT TIME OF PLACEMENT OF EROSION CONTROL MEASURES WILL VARY. APPROPRIATE ACTION INCLUDING TEMPORARY SWALES, INLETS, HYDROSEEDING, STRAW BALES, ROCK SACKS, ETC. SHALL BE TAKEN TO PREVENT EROSION AND SEDIMENTATION FROM LEAVING SITE. EROSION CONTROL MEASURES SHALL BE ADJUSTED AS THE CONDITIONS CHANGE AND THE NEED OF CONSTRUCTION SHIFT.
- 3. CONSTRUCTION ENTRANCES SHALL BE INSTALLED PRIOR TO COMMENCEMENT OF GRADING. ALL CONSTRUCTION TRAFFIC ENTERING ONTO THE PAVED ROADS MUST CROSS THE STABILIZED CONSTRUCTION ENTRANCES. CONTRACTOR SHALL MAINTAIN STABILIZED ENTRANCE AT EACH VEHICLE ACCESS POINT TO EXISTING PAVED STREETS. ANY MUD OR DEBRIS TRACKED ONTO PUBLIC STREETS SHALL BE REMOVED DAILY AND AS REQUIRED BY THE GOVERNING AGENCY.
- 4. ALL EXPOSED SLOPES THAT ARE NOT VEGETATED SHALL BE HYDROSEEDED. IF HYDROSEEDING IS NOT USED OR IS NOT EFFECTIVE BY OCTOBER 15, THEN OTHER IMMEDIATE METHODS SHALL BE IMPLEMENTED, SUCH AS EROSION CONTROL BLANKETS, OR A THREE—STEP APPLICATION OF 1) SEED, MULCH, FERTILIZER 2) BLOWN STRAW 3) TACKIFIER AND MULCH. HYDROSEEDING SHALL BE IN ACCORDANCE WITH THE PROVISIONS OF SECTION 20" EROSION CONTROL AND HIGHWAY PLANTING" OF THE STANDARD SPECIFICATION OF THE STATE OF CALIFORNIA DEPARTMENT OF TRANSPORTATION, AS LAST REVISED. REFER TO THE EROSION CONTROL SECTION OF THE GRADING SPECIFICATIONS THAT ARE A PART OF THIS PLAN SET FOR FURTHER INFORMATION.
- 5. INLET PROTECTION SHALL BE INSTALLED AT OPEN INLETS TO PREVENT SEDIMENT FROM ENTERING THE STORM DRAIN SYSTEM. INLETS NOT USED IN CONJUNCTION WITH EROSION CONTROL ARE TO BE BLOCKED TO PREVENT ENTRY OF SEDIMENT. MINIMUM INLET PROTECTION SHALL CONSIST OF A ROCK SACKS OR AS SHOWN ON THIS PLAN
- 6. THIS EROSION AND SEDIMENT CONTROL PLAN MAY NOT COVER ALL THE SITUATIONS THAT MAY ARISE DURING CONSTRUCTION DUE TO UNANTICIPATED FIELD CONDITIONS. VARIATIONS AND ADDITIONS MAY BE MADE TO THIS PLAN IN THE FIELD. A REPRESENTATIVE OF LEA & BRAZE ENGINEERING SHALL PERFORM A FIELD REVIEW AND MAKE RECOMMENDATIONS AS NEEDED. CONTRACTOR IS RESPONSIBLE TO NOTIFY LEA & BRAZE ENGINEERING AND THE GOVERNING AGENCY OF ANY CHANGES.
- 7. THE EROSION CONTROL MEASURES SHALL CONFORM TO THE LOCAL JURISDICTION'S STANDARDS AND THE APPROVAL OF THE LOCAL JURISDICTION'S ENGINEERING DEPARTMENT.
- 8. STRAW ROLLS SHALL BE PLACED AT THE TOE OF SLOPES AND ALONG THE DOWN SLOPE PERIMETER OF THE PROJECT. THEY SHALL BE PLACED AT 25 FOOT INTERVALS ON GRADED SLOPES. PLACEMENT SHALL RUN WITH THE CONTOURS AND ROLLS SHALL BE TIGHTLY END BUTTED. CONTRACTOR SHALL REFER TO MANUFACTURES SPECIFICATIONS FOR PLACEMENT AND INSTALLATION INSTRUCTIONS.

PURPOSE:

THE PURPOSE OF THIS PLAN IS TO STABILIZE THE SITE TO PREVENT EROSION OF GRADED AREAS AND TO PREVENT SEDIMENTATION FROM LEAVING THE CONSTRUCTION AREA AND AFFECTING NEIGHBORING SITES, NATURAL AREAS, PUBLIC FACILITIES OR ANY OTHER AREA THAT MIGHT BE AFFECTED BY SEDIMENTATION. ALL MEASURES SHOWN ON THIS PLAN SHOULD BE CONSIDERED THE MINIMUM REQUIREMENTS NECESSARY. SHOULD FIELD CONDITIONS DICTATE ADDITIONAL MEASURES, SUCH MEASURES SHALL BE PER CALIFORNIA REGIONAL WATER QUALITY CONTROL BOARD'S FIELD MANUAL FOR EROSION AND SEDIMENTATION CONTROL AND THE CALIFORNIA STORM WATER QUALITY ASSOCIATION BEST MANAGEMENT PRACTICES HANDBOOK FOR CONSTRUCTION. LEA & BRAZE ENGINEERING SHOULD BE NOTIFIED IMMEDIATELY SHOULD CONDITIONS CHANGE.

PERIODIC MAINTENANCE:

- 1. MAINTENANCE IS TO BE PERFORMED AS FOLLOWS:
- A. DAMAGES CAUSED BY SOIL EROSION OR CONSTRUCTION SHALL BE REPAIRED AT THE END OF EACH WORKING DAY.
- B. SWALES SHALL BE INSPECTED PERIODICALLY AND MAINTAINED AS
- C. SEDIMENT TRAPS, BERMS, AND SWALES ARE TO BE INSPECTED AFTER EACH STORM AND REPAIRS MADE AS NEEDED.
- D. SEDIMENT SHALL BE REMOVED AND SEDIMENT TRAP RESTORED TO ITS ORIGINAL DIMENSIONS WHEN SEDIMENT HAS ACCUMULATED TO A DEPTH OF 1' FOOT.
- E. SEDIMENT REMOVED FROM TRAP SHALL BE DEPOSITED IN A SUITABLE AREA AND IN SUCH A MANNER THAT IT WILL NOT ERODE.
- F. RILLS AND GULLIES MUST BE REPAIRED.
- 2. GRAVEL BAG INLET PROTECTION SHALL BE CLEANED OUT WHENEVER SEDIMENT DEPTH IS ONE HALF THE HEIGHT OF ONE GRAVEL BAG.
- 3. STRAW ROLLS SHALL BE PERIODICALLY CHECKED TO ASSURE PROPER FUNCTION AND CLEANED OUT WHENEVER THE SEDIMENT DEPTH REACHED HALF THE HEIGHT OF THE ROLL.
- 4. SILT FENCE SHALL BE PERIODICALLY CHECKED TO ASSURE PROPER FUNCTION AND CLEANED OUT WHENEVER THE SEDIMENT DEPTH REACHES ONE FOOT IN HEIGHT.
- 5. CONSTRUCTION ENTRANCE SHALL BE REGRAVELED AS NECESSARY FOLLOWING SILT/SOIL BUILDUP.
- 6. ANY OTHER EROSION CONTROL MEASURES SHOULD BE CHECKED AT REGULAR INTERVALS TO ASSURE PROPER FUNCTION

REFERENCES:

- 1. CALIFORNIA REGIONAL WATER QUALITY CONTROL BOARD'S FIELD MANUAL FOR EROSION AND SEDIMENTATION CONTROL
- 2. CALIFORNIA STORM WATER QUALITY ASSOCIATION BEST MANAGEMENT PRACTICES HANDBOOK FOR CONSTRUCTION

EROSION CONTROL LEGEND

GRAVEL BAG DIKE

SEDIMENTATION BASIN

STRAW ROLL

NOTE:
SEAL ALL OTHER INLETS NOT INTENDED
TO ACCEPT STORM WATER AND DIRECT
FLOWS TEMPORARILY TO FUNCTIONAL

SEDIMENTATION BASIN INLETS. -TYP

EROSION CONTROL MEASURES SHALL BE IN PLACE AND MAINTAINED FROM OCTOBER 15 TO APRIL 15 AS REQUIRED.

NOTE:
EROSION CONTROL IS ONLY REQUIRED
IMMEDIATELY DOWNHILL OF ANY
CONSTRUCTION IN PROGRESS. EROSION
CONTROL MEASURES CAN BE RELOCATED
AS NECESSARY AND STILL FUNCTION

No. 63127
Exp. 06-30-12

CIVIL
SIGNATURES IN BUILD

CIVIL

ERS · LAND SURVEYOR
SACRAMENTO REGION
3017 DOUGLAS BLVD, #
ROSEVILLE, CA 95661

AY AREA REGION SA(495 INDUSTRIAL PKWY WEST 301 AYWARD, CALIFORNIA 94545 RO(5) (510) 887–4086 (P)

AACT 6102 INCIC DRIVE N TOWNSHIP

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ROSION CONTROL PLAN

 \Box

DATE: 8-5-11SCALE: 1" = 60'DESIGN BY: JR/RC

DRAWN BY: TB

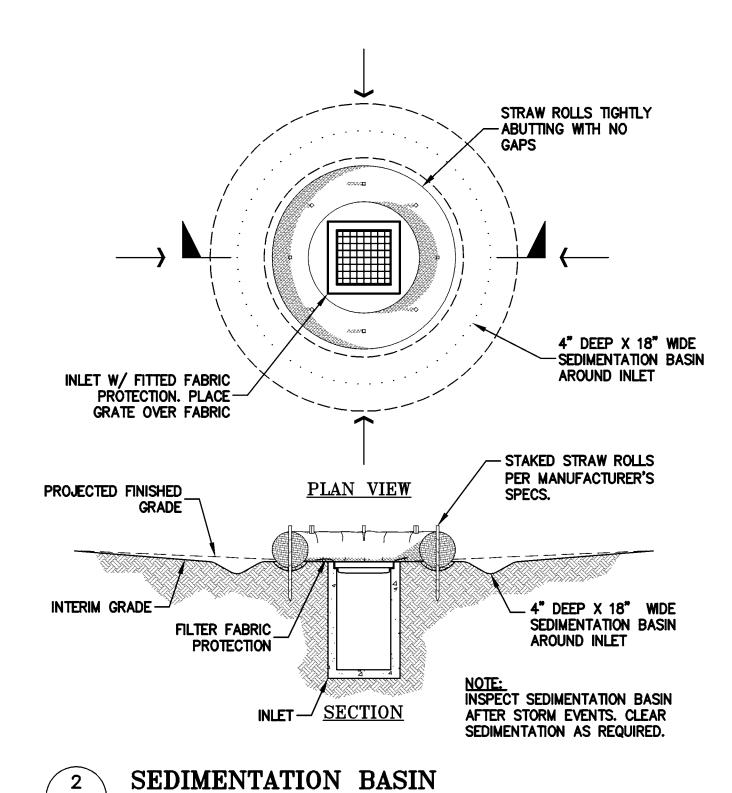
ER-1

21 OF 22 SHEETS

SHEET NO:

NOTE: THREE LAYERS OF GRAVEL BAGS WITH ENDS OVERLAPPED

1 GRAVEL BAG DIKE ER-2 NTS

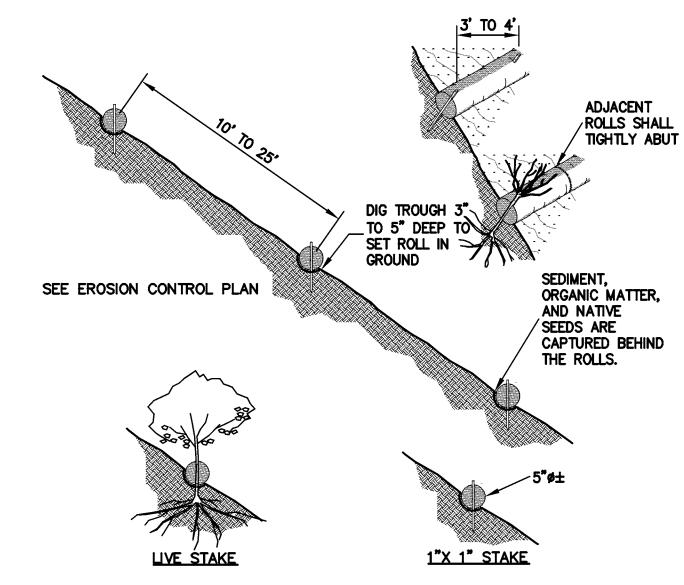


6" COBBLE STONE MIN

FILTER FABRIC TO COVER INLET

4 INLET PROTECTION NTS

ER-2



NOTE:

1. STRAW ROLL INSTALLATION REQUIRES THE PLACEMENT AND SECURE STAKING OF THE ROLL IN A TRENCH, 3" TO 5" DEEP, DUG ON CONTOUR. RUNOFF MUST NOT BE ALLOWED TO RUN UNDER OR AROUND ROLL.

2. CONTRACTOR IS RESPONSIBLE FOR REGULAR MAINTENANCE AND INSPECTION. THE SILT SHALL BE CLEANED OUT WHEN IT REACHES HALF THE HEIGHT OF THE ROLL.

3 STRAW ROLLS
ER-2 NTS

TRACT 6102 JELINCIC DRIVE EDEN TOWNSHIP

> EROSION CONTROL DETAILS

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REVISIONS		BY	
JOB NO:	2100	2100094	
DATE:	8-5-11		
SCALE:	DALE: AS NOTED		

DATE: 8-5-11

SCALE: AS NOTED

DESIGN BY: JR/RC

DRAWN BY: TB

ET NO: